CHATHAM COUNTY PURCHASING DEPARTMENT

ADDENDUM NO. <u>1</u> TO <u>BID NO. 13-0107-4</u>

FOR: CLOVERDALE COMMUNITY CENTER

PLEASE SEE THE FOLLOWING FOR ADDITIONS, CLARIFICATIONS AND/OR CHANGES:

NOTE: Please see the following attached REVISED Plan Sheets:

C13- MISC DETAILS - 111213

CL-A-0- REVISED 11-19-13

CL-A-1- REVISED 11-119-13

CL-A-2- REVISED 11-19-13

CL-A-3- REVISED 11-19-13

CL-A-4- REVISED 11-19-13

CL-A-5- REVISED 11-19-13

NOTE: Please see the attached Division 7 Technical Specifications:

07200 Icon CMU Inserts (2 sheets) 07610 Sheet Metal Roofing (4 sheets)

See attached Civil Engineering REVISED plan sheets:

C-5, C-7, C-9, C-10, C-12 & L-1

- 1. Drawings C-5, C-7, C-9, C-10, C-12 & L-1 have been revised as indicated by revision clouds as shown on attached drawings.
- 2. Asphalt concrete and aggregate base for road construction shall conform to Section 02200 "Earthwork", and Section 02600 "Pavement" of the standard City Technical Specifications with regards to material, installation and testing requirements. Note that all site construction shall conform to City standards.
- 3. Disregard note on Drawing C-4 which reads "Matchline, see detention basin modifications, Dwg C13". No detention basin modifications will be required.
- 4. Water meters (meter only) shall be provided and installed by the City of Savannah.
- 5. The contractor shall coordinate the schedule and duration of any disruption of water or sewer service to the Butler Elementary Campus. Disruptions shall be minimized.

NOTE: MEP revisions:

1. Plumbing Fixture Schedule:

Change 2CS to become a 3CS and read:

"3CS, Three compartment sink, counter mounted, ADA rates, self-rimming, 18 GA. stainless steel, 16" X 14" X 6" deep bowl, dishwasher waste connection, Just TL-2249-A-GR-ADA

Change Note #15 in notes column for @CS to become new Note 18. Add Note 18 that reads "Single lever faucet with 12" long spout and aerator, Moen Faucet #8722".

Waste Water Diagram: Change "2CS to read 3CS".

SHEET P-2 Water Riser Diagram Change "2CS to read "3CS".

Responses to Questions received:

- 1. Q) Please verify the limits of the pervious pavers is it just in the 4 spots on the plans that show the pavers design, or is it for the whole parking area and drives starting & ending at the 2 sections of header curb?
- A) It is the entire parking lot bounded by the header curbs.
- 2. Q) Drawings show sliding windows, specs call for non-impact in-swinging awning type with rates glass. Please clarify.
- A) See revised sheet A-2, date 11-22-13. Windows shall be pre-finished aluminum windows, horizontal slider with insect screens, lock, low-E, impact glazing.
- 3. Q) What is the hardware to be for the aluminum storefront doors?
- A) Entrance storefront hardware: See revised sheet A-3. Mid-rail, flush panic device with manufacturer provided locking.
- 4.Q) What type of insulation is called for this project?
- A) CMU walls shall be fitted with "Icon" inserts See specification 07200. Spray foam insulation shall be applied to the underside of the roof assembly, min R-30.
- 5. Q) Do then subcontractors need to be bonded?
- A) Chatham County requires Bid, Payment & Performance Bonds from the Prime Contractor only.
- 6. Q) Please verify limits or pervious pavers.
- A) It is the entire parking lot bounded by the header curbs.

7. Q) In section 16705-8, 3-3, A,6, it says "Terminate voice backbone cable to voice (cat 3 or 5) pin patch on both ends". I see no other reference to a voice or data backbone. Is there a backbone? If so, how long, how many pair?

A) There is no data backbone.

ADDITIONAL CLARIFICATIONS:

Ceramic Tile : Floor Tile 8×8 , wall tile 4×4 nominal dimensions with cove base and associated trim tiles.

All ADA 2010 accessibility requirements apply to this project.

Kitchen counter shall be 34" AFF and knee space shall be provided at the sinks. Wall cabinets must comply with ADA reach heights.

BID OPENING REMAINS: 2PM, DECEMBER 3, 2013

11-27-13 DATE

ROBERT E. MARSHALL
SENIOR PROCUREMENT SPECIALIST
CHATHAM COUNTY

CLOVERDALE COMMUNITY CENTER

1909 CYNTHIA STREET, SAVANNAH GEORGIA 31415

NEW FENCE TO CONNECT TO EXISTING SCHOOL FENCE & LIMITS OF DISTURBANCE

GENERAL NOTES:

- 1. ALL WORK UNDER THIS CONTRACT SHALL CONFORM TO ALL CODES, ORDINANCES, AND REGULATIONS OF ALL AUTHORITIES HAVING JURISDICTION OVER THIS WORK WHETHER SHOWN IN THESE DOCUMENTS OR NOT.
- 2. THE CONTRACTOR SHALL SECURE AND PAY FOR ALL NECESSARY PERMITS AND INSPECTIONS.
- 3. THE CONTRACTOR SHALL SECURE AND PAY FOR ALL INSURANCE CALLED FOR BY LAW AND AS DIRECTED BY THE OWNER OR FUNDING INSTITUTION. COPIES OF INSURANCE CERTIFICATES SHALL BE FILED WITH THE ARCHITECT AND/OR OWNER.
- 4. THE "GENERAL CONDITIONS OF THE CONTRACT FOR CONSTRUCTION" A.I.A. DOCUMENT A201, CURRENT ADDITION IS HEREBY MADE A PART OF THIS CONTRACT AND SHALL BE AS BINDING AS IF CONTAINED HEREIN IN FULL. A COPY OF THIS DOCUMENT IS AVAILABLE FOR INSPECTION AT THE ARCHITECTS' OFFICE.
- 5. THE CONTRACTOR SHALL COORDINATE HIS/HER WORK WITH THE WORK OF THE OWNER'S ADDITONAL CONTRACTORS AS NECESSARY FOR THE UNINTERUPTED FLOW OF WORK.
- 6. THE MANUFACTURED ITEMS, EQUIPMENT, AND ASSEMBLIES SHALL BE INSTALLED IN STRICT COMPLIANCE WITH THE MANUFACTURER'S PRINTED INSTRUCTIONS FOR INSTALLATION UNLESS OTHERWISE SPECIFICALLY INDICATED IN THESE CONSTRUCTION DOCUMENTS.
- 7. ALL THE DRAWINGS WITHIN THIS SET OF DRAWINGS ARE COMPLEMENTARY. THE GENERAL CONTRACTOR IS RESPONSIBLE FOR PROVIDING ALL THE SUBCONTRACTORS WITH A COMPLETE SET OF DOCUMENTS. DO NOT ISSUE INCOMPLETE SETS OF DRAWINGS.

PLAN REVIEW DATA

1. ARCHITECT OF RECORD LOMINACK KOLMAN SMITH ARCHITECTS ANNE K. SMITH, AIA,

2. OWNER / CONTACT

CITY OF SAVANNAH
GREGORI ANDERSON, PROJECT MANAGER, CHATHAM COUNTY

3. PROJECT DESCRIPTION

THIS PROJECT IS A NEW COMMUNITY CENTER WITH AN OFFICE, COMPUTER ROOM, EXERCISE ROOM, RESTROOMS, MULTI-PURPOSE ROOM, WARMING/CATERING KITCHEN, AND ASSOCIATED SUPPORT SPACES.

4. GROSS SQUARE FOOTAGE TOTAL BUILDING:

5350 SQUARE FEET MULTI-PURPOSE ROOM: 1913 SQUARE FEET

5. APPLICABLE CODES

INTERNATIONAL BUILDING CODE, 2006 EDITION, WITH GEORGIA

LIFE SAFETY CODE (NFPA 101), 2000 EDITION, WITH GEORGIA

AMENDMENTS
INTERNATIONAL ENERGY CONSERVATION CODE, 2009 EDITION,

WITH GEORGIA AMENDMENTS AMERICANS WITH DISABILITIES ACT - 2010

- A. OCCUPANCY CLASSIFICATION: ASSEMBLY, A-3, (ASSEMBLY USES FOR WORSHIP, RECREATION, OR
- AMUSEMENT...)
- C. SPRINKLERED: NO (NOT REQUIRED PER IBC 903.2.1.3)

CONSTRUCTION TYPE: iii-B, TABLE 601, IBC CODE


D. OCCUPANT LOAD:

MULTI-PURPOSE ROOM, 1913 NET SF/15 = 128 COMMUNITY CENTER (MINUS MULTI-PURPOSE ROOM) 3437 GROSS SF/100 = 35 PEOPLE (BUSINESS OCCUPANCY) TOTAL OCCUPANTS = 163 PEOPLE

E. MEANS OF EGRESS REQUIRED:
COMMUNITY CENTER:
1 EXIT REQUIRED; 1 PROVIDED
MULI-PURPOSE ROOM:
2 EXITS REQUIRED; 2 PROVIDED

LIST OF DRAWINGS

A-0	COVER SHEET
	CIVIL
C1	CIVIL COVER
C2	EXISTING CONDITIONS PLAN
C3	SITE LAYOUT PLAN
C3	GRADING AND DRAINAGE PLAN
C5	CIVIL UTILITIES PLAN
C6	UTILITIES PROFILES
C7	EROSION AND SEDIMENT
	CONTROL DETAILS
C8	EROSION AND SEDIMENT
	CONTROL NOTES
C9	EROSION AND SEDIMENT
	CONTROL PLAN (PHASE 1)
C10	EROSION AND SEDIMENT
	CONTROL PLAN (PHASE 2)
C11	EROSION AND SEDIMENT
	CONTROL PLAN (PHASE 3)
C12	MISCELLANEOUS DETAILS
C13	MISCELLANEOUS DETAILS
	LANDSCAPE
L1	LANDSCAPE PLAN
	ARCHITECTURAL
A-1	FLOOR PLAN / DIMENSION CONTROL
A-2	ROOF PLAN / ELEVATIONS
A-3	BUILDING SECTIONS
A-4	INTERIOR ELEVATIONS / FINISHES
A-5	BATHROOM ELEVATIONS
	STRUCTURAL
	STRUCTURAL
S0	STRUCTURAL NOTES
S1	FOUNDATION PLAN & DETAILS
S2	ROOF FRAMING PLAN AND DETAILS
S3	MISCELLANEOUS DETAIL
	MECHANICAL
M1	MECHANICAL PLAN
	PLUMBING
P1 P2	WASTE WATER
	ELECTRICAL

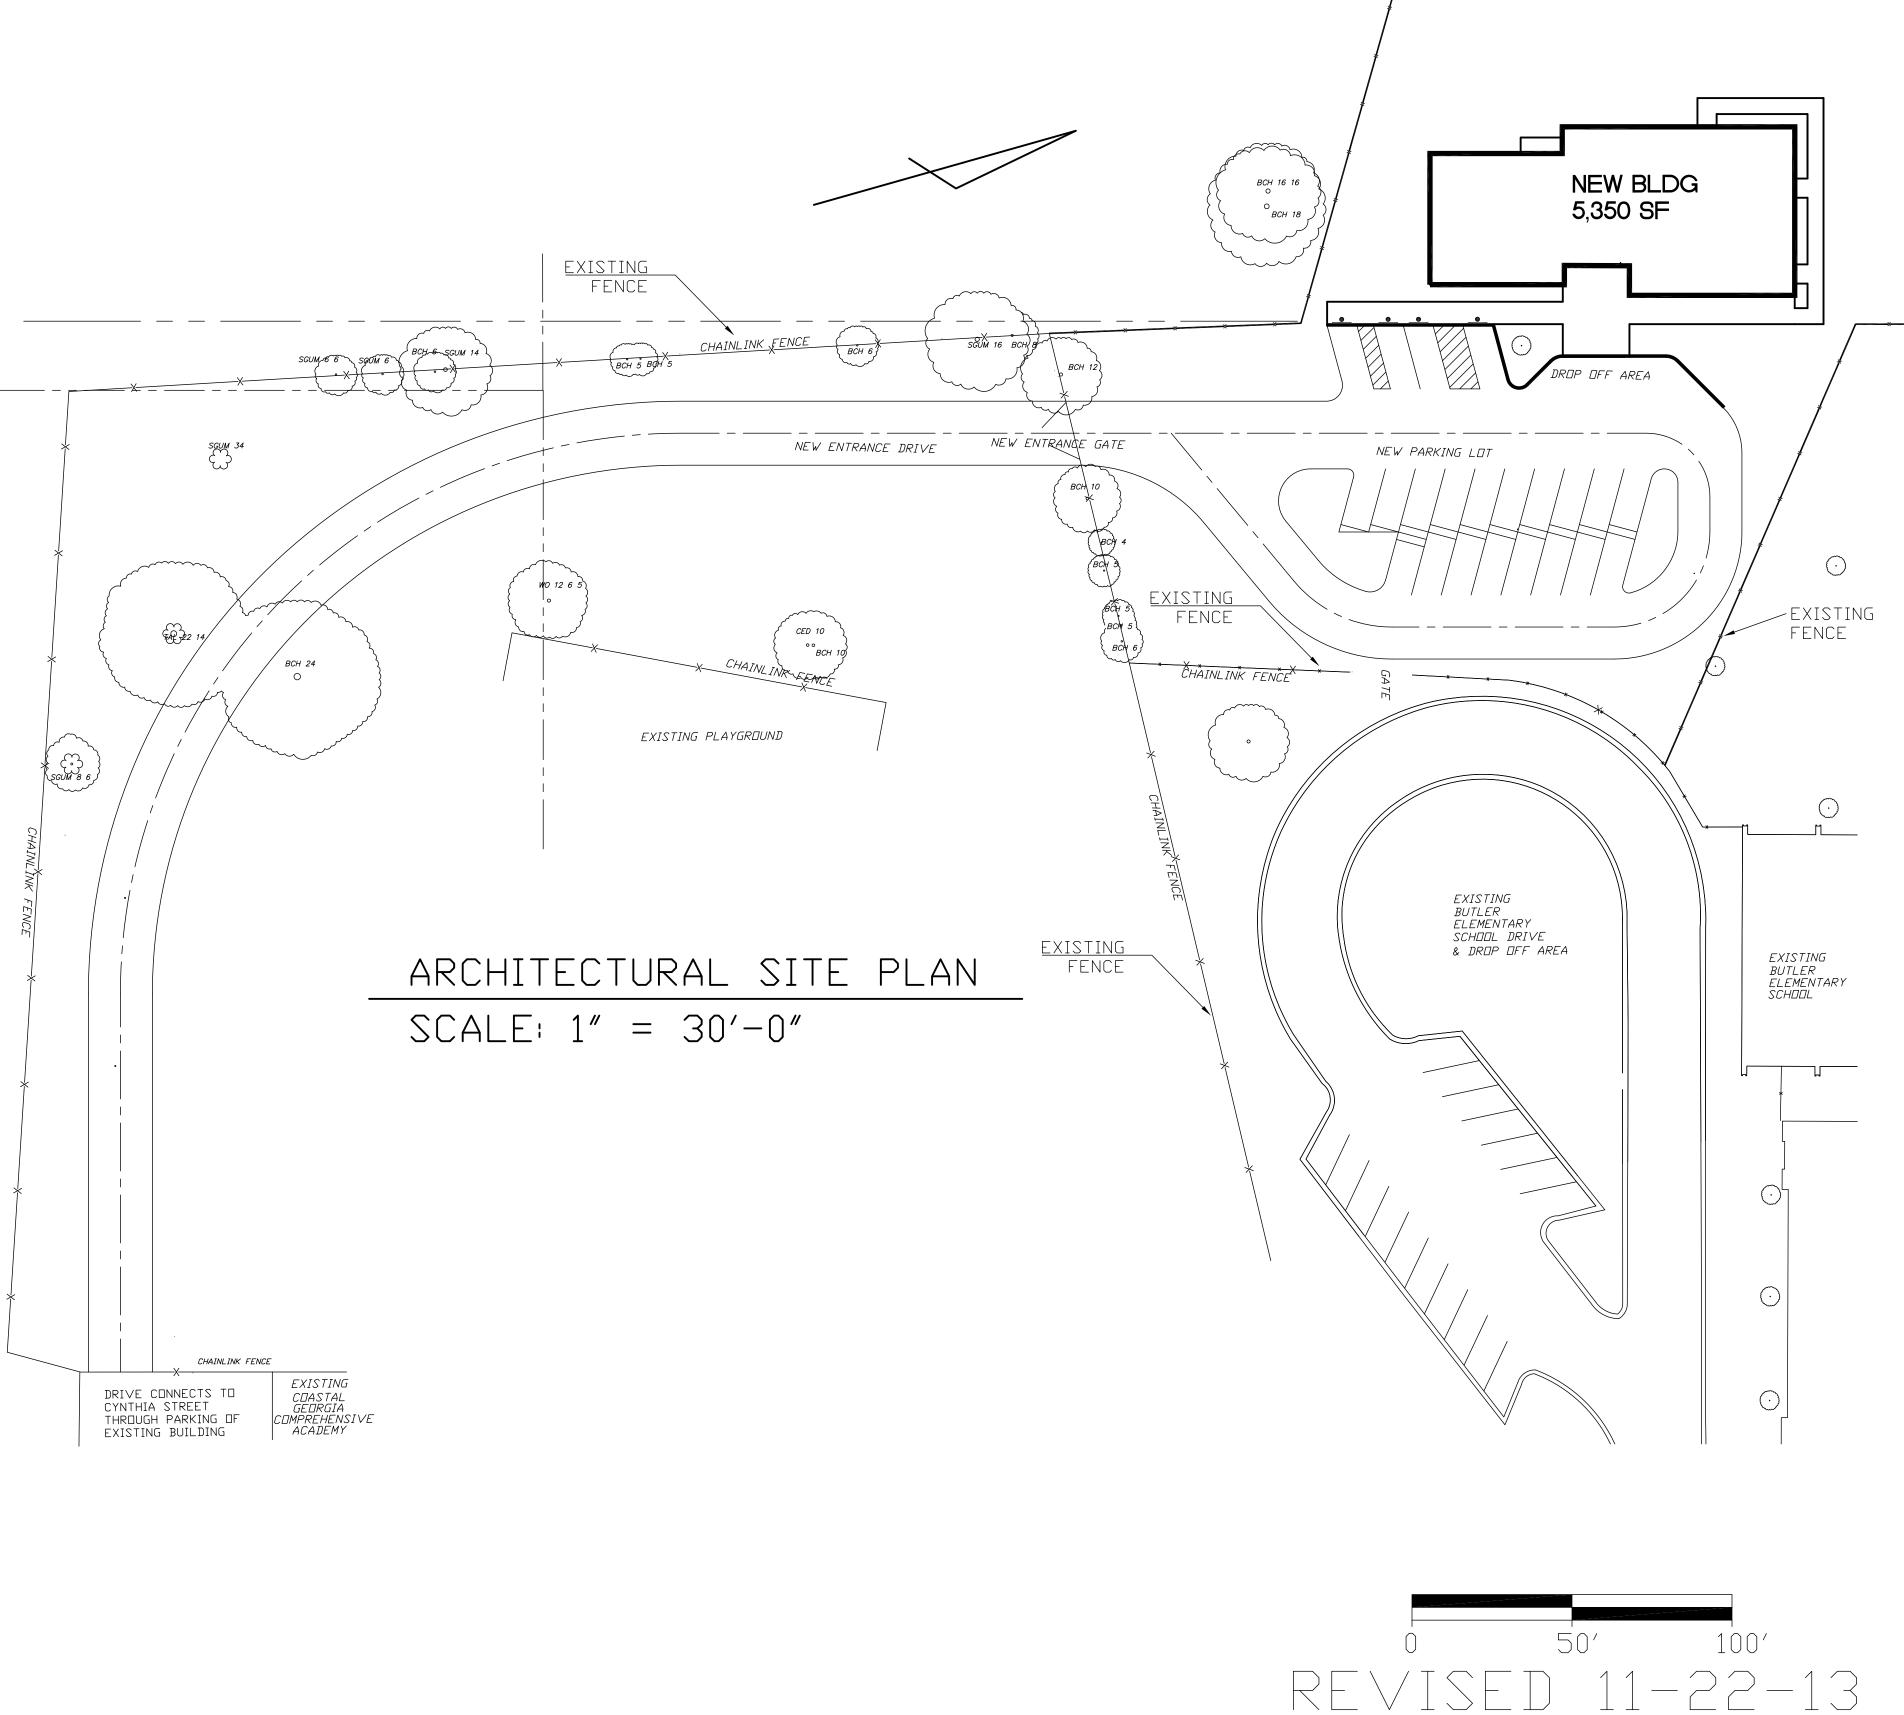



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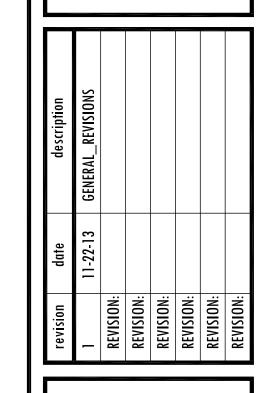


consultants:

COASTAL CIVIL ENGINEERING

SAUSSY ENGINEERING

SMITH & VANDENBULCK ENGINEERS




CLOVERDALE
COMMUNITY CENTER
SAVANNAH, GEORGIA


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date: 10/21/13
job number: 1207
drawn by: JRK/AKS
checked by: AKS

SHEET:

A-0



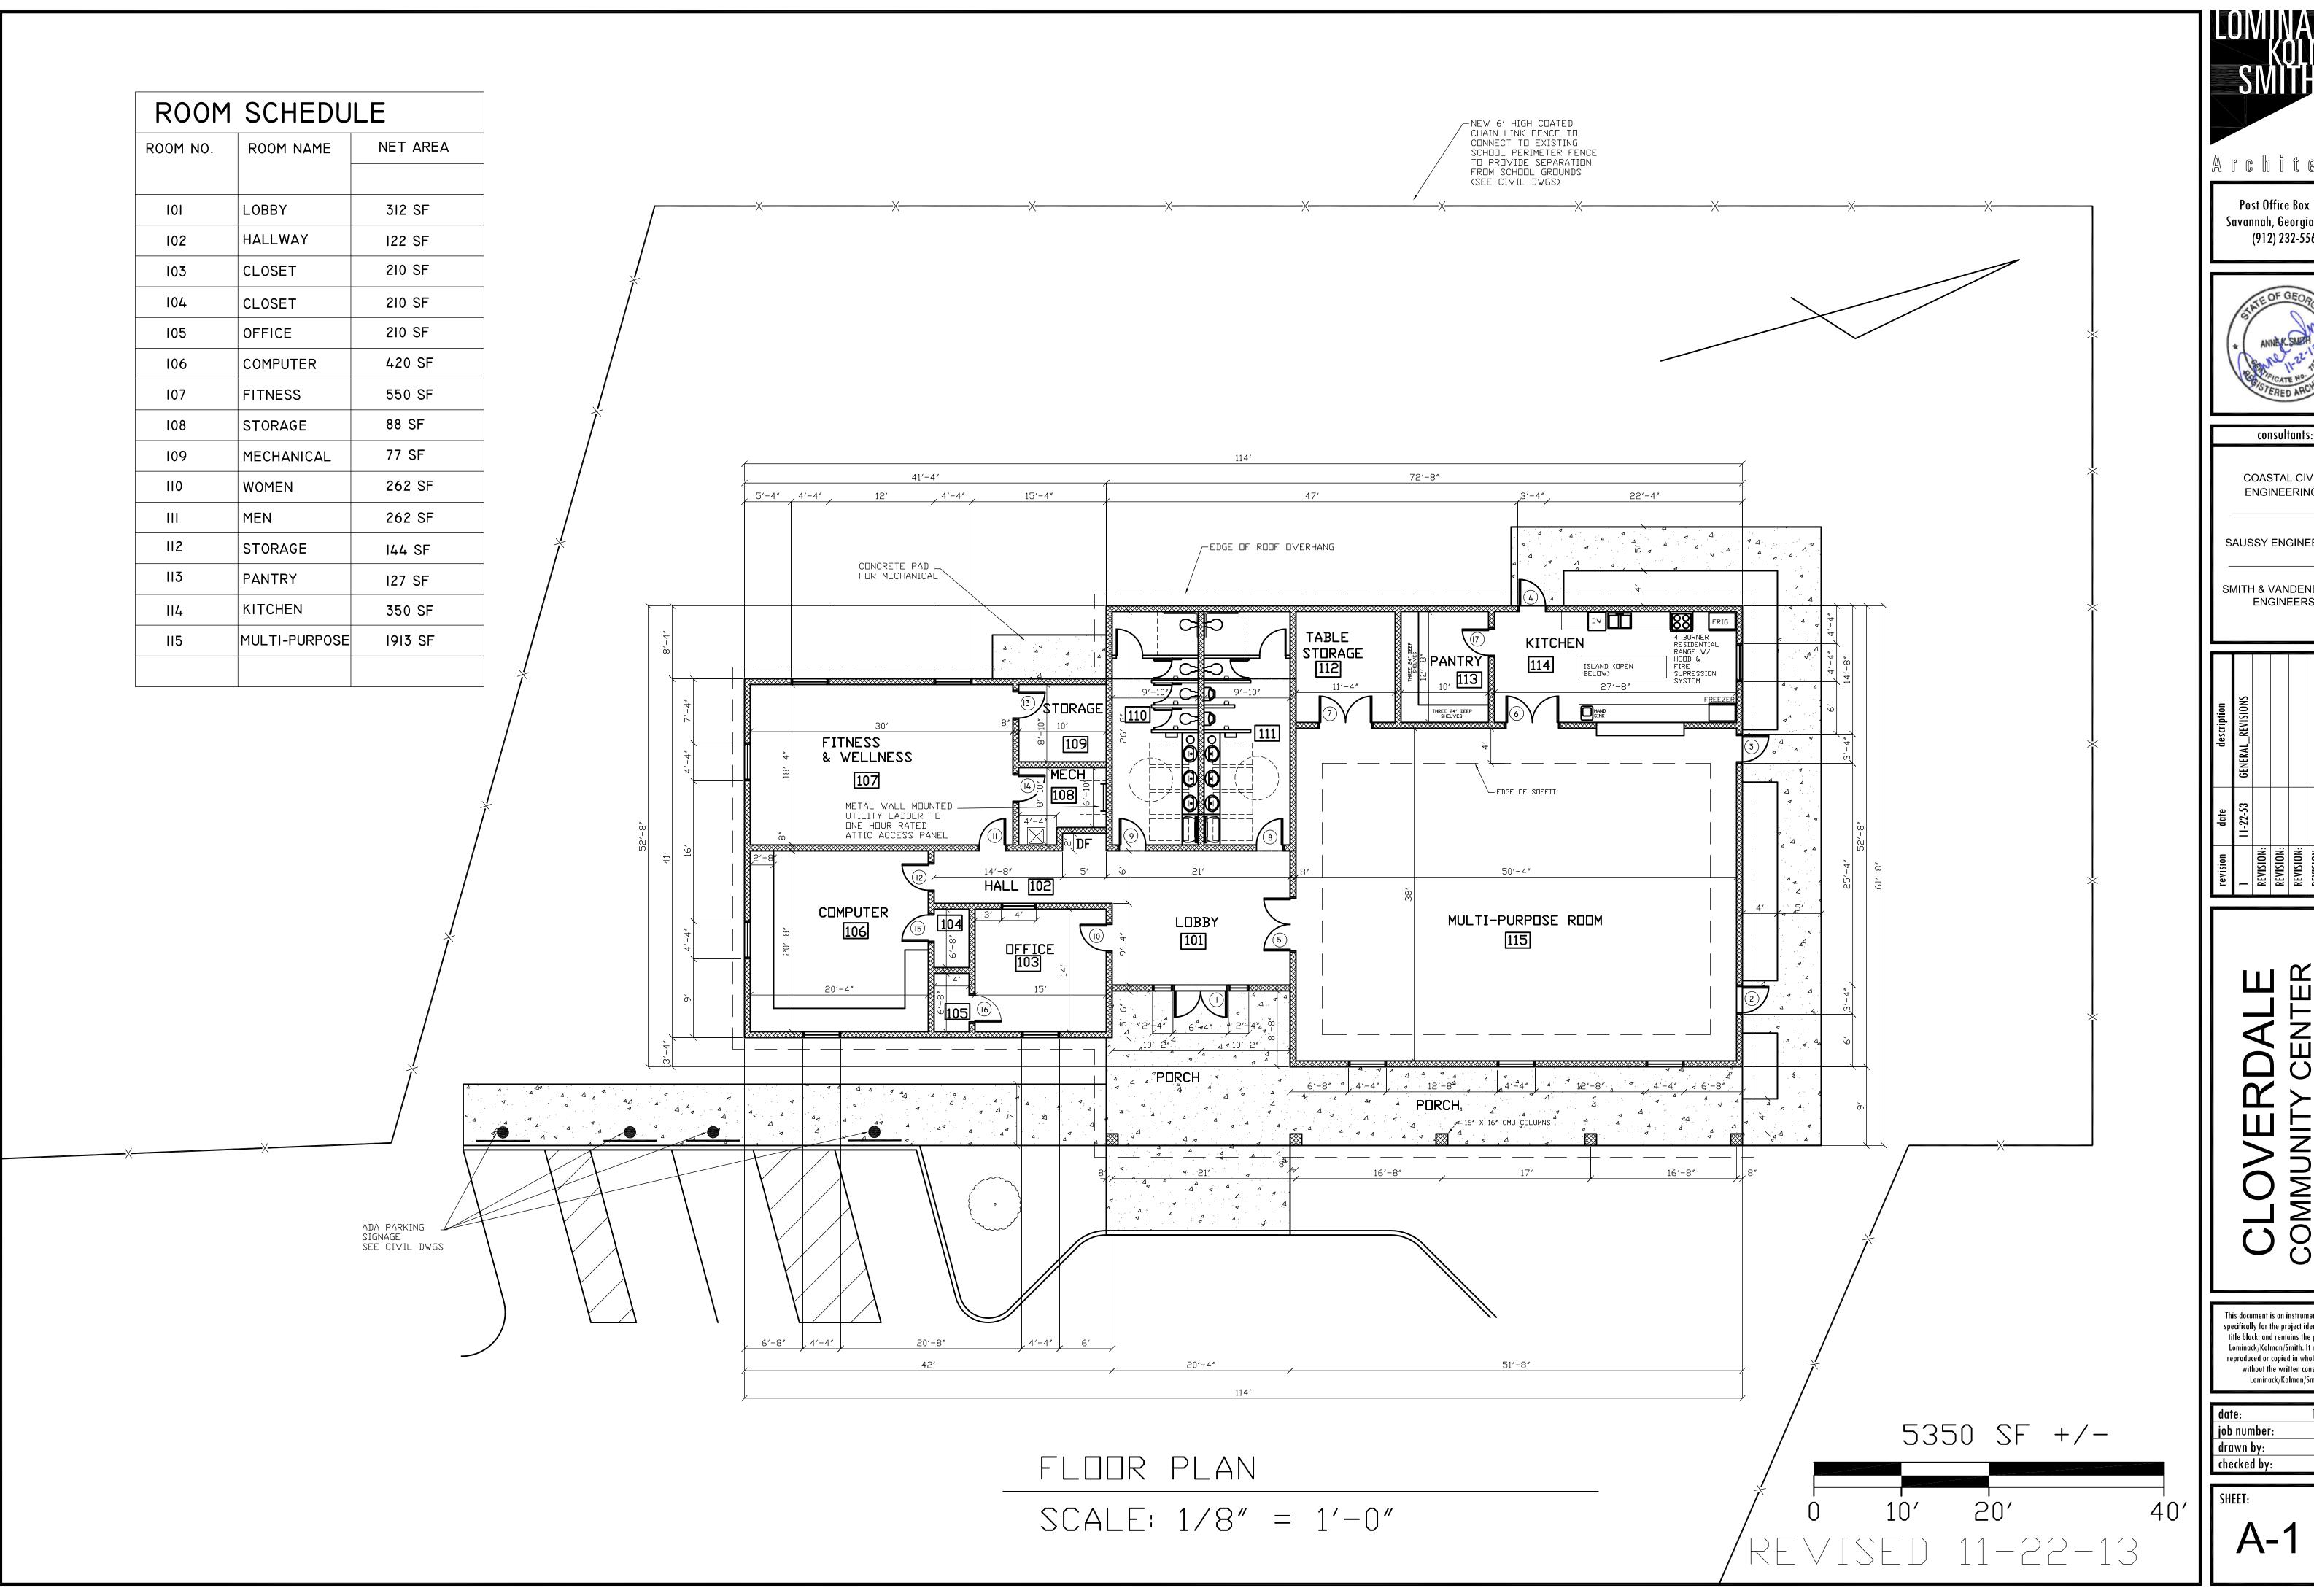
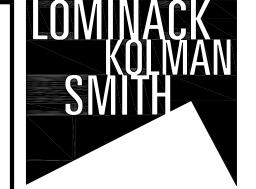
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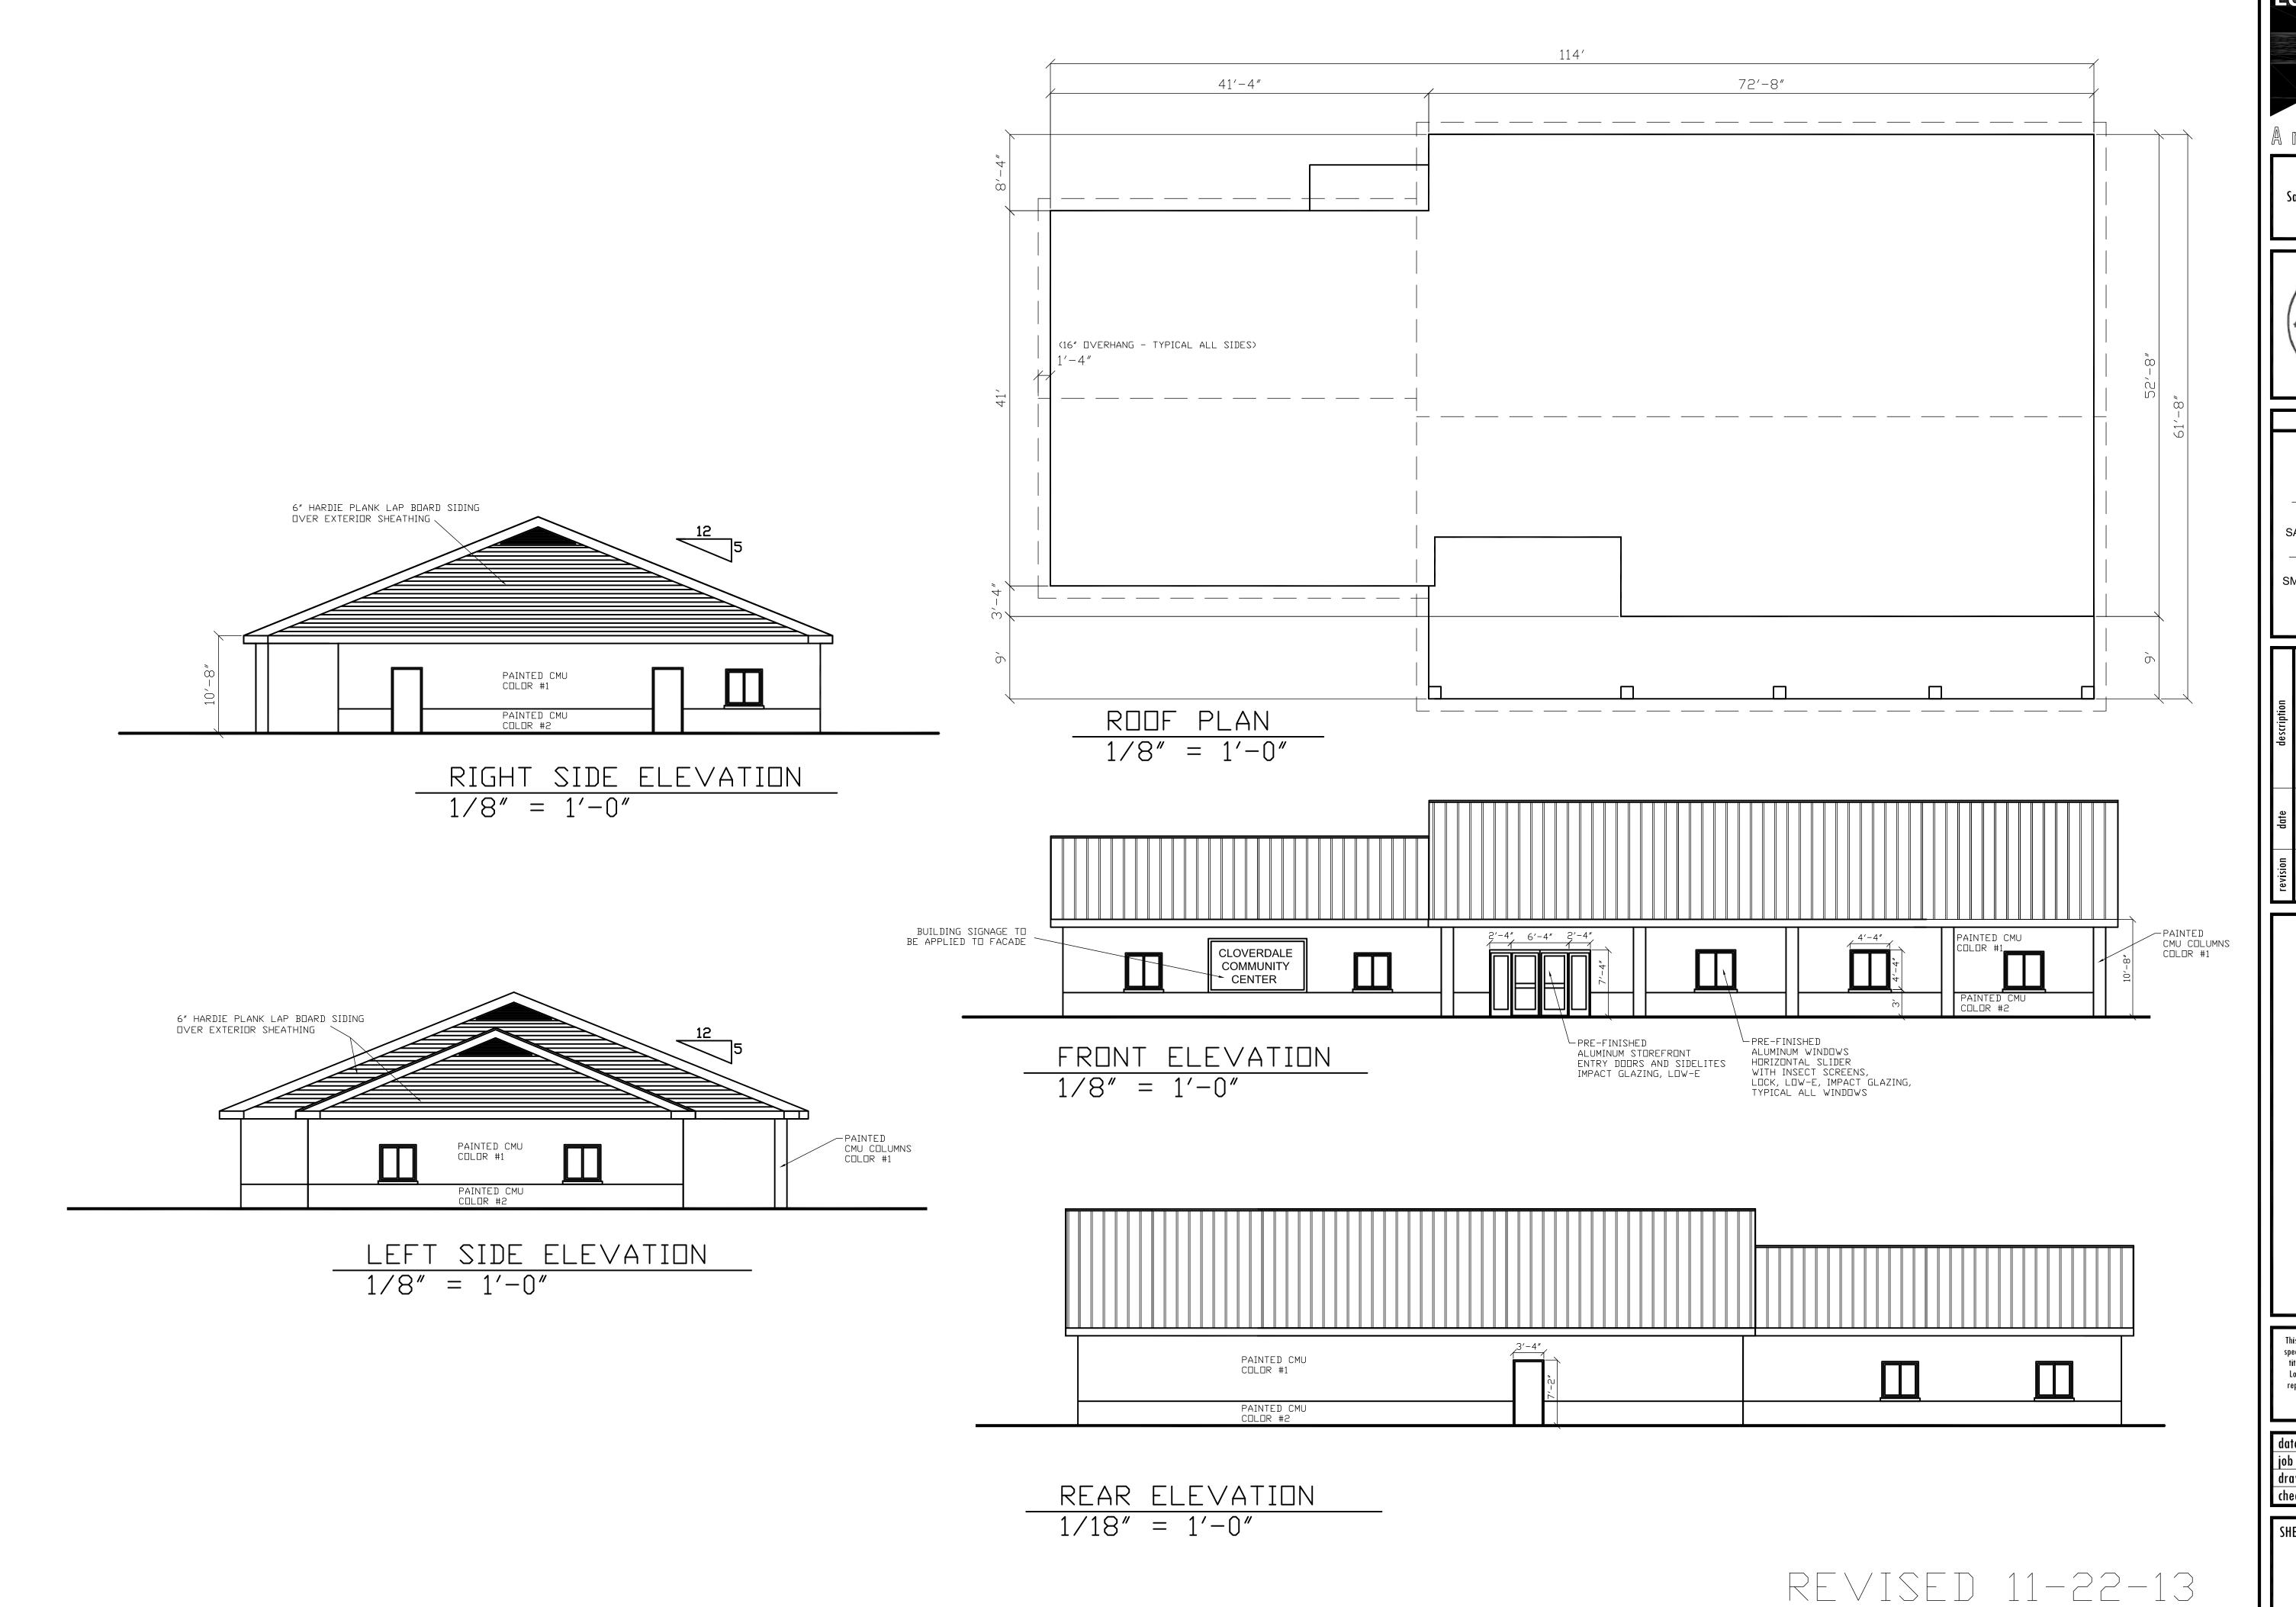
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SMITH & VANDENBULCK **ENGINEERS**

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	description	GENERAL_REVISIONS						
	date	11-22-53						
	revision	l	REVISION:	REVISION:	REVISION:	REVISION:	REVISION:	REVISION:

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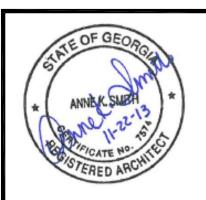
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checked by:	AKS





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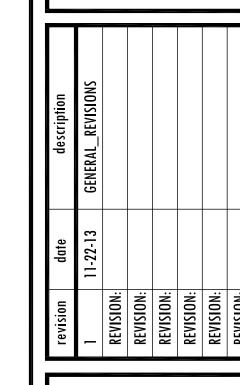
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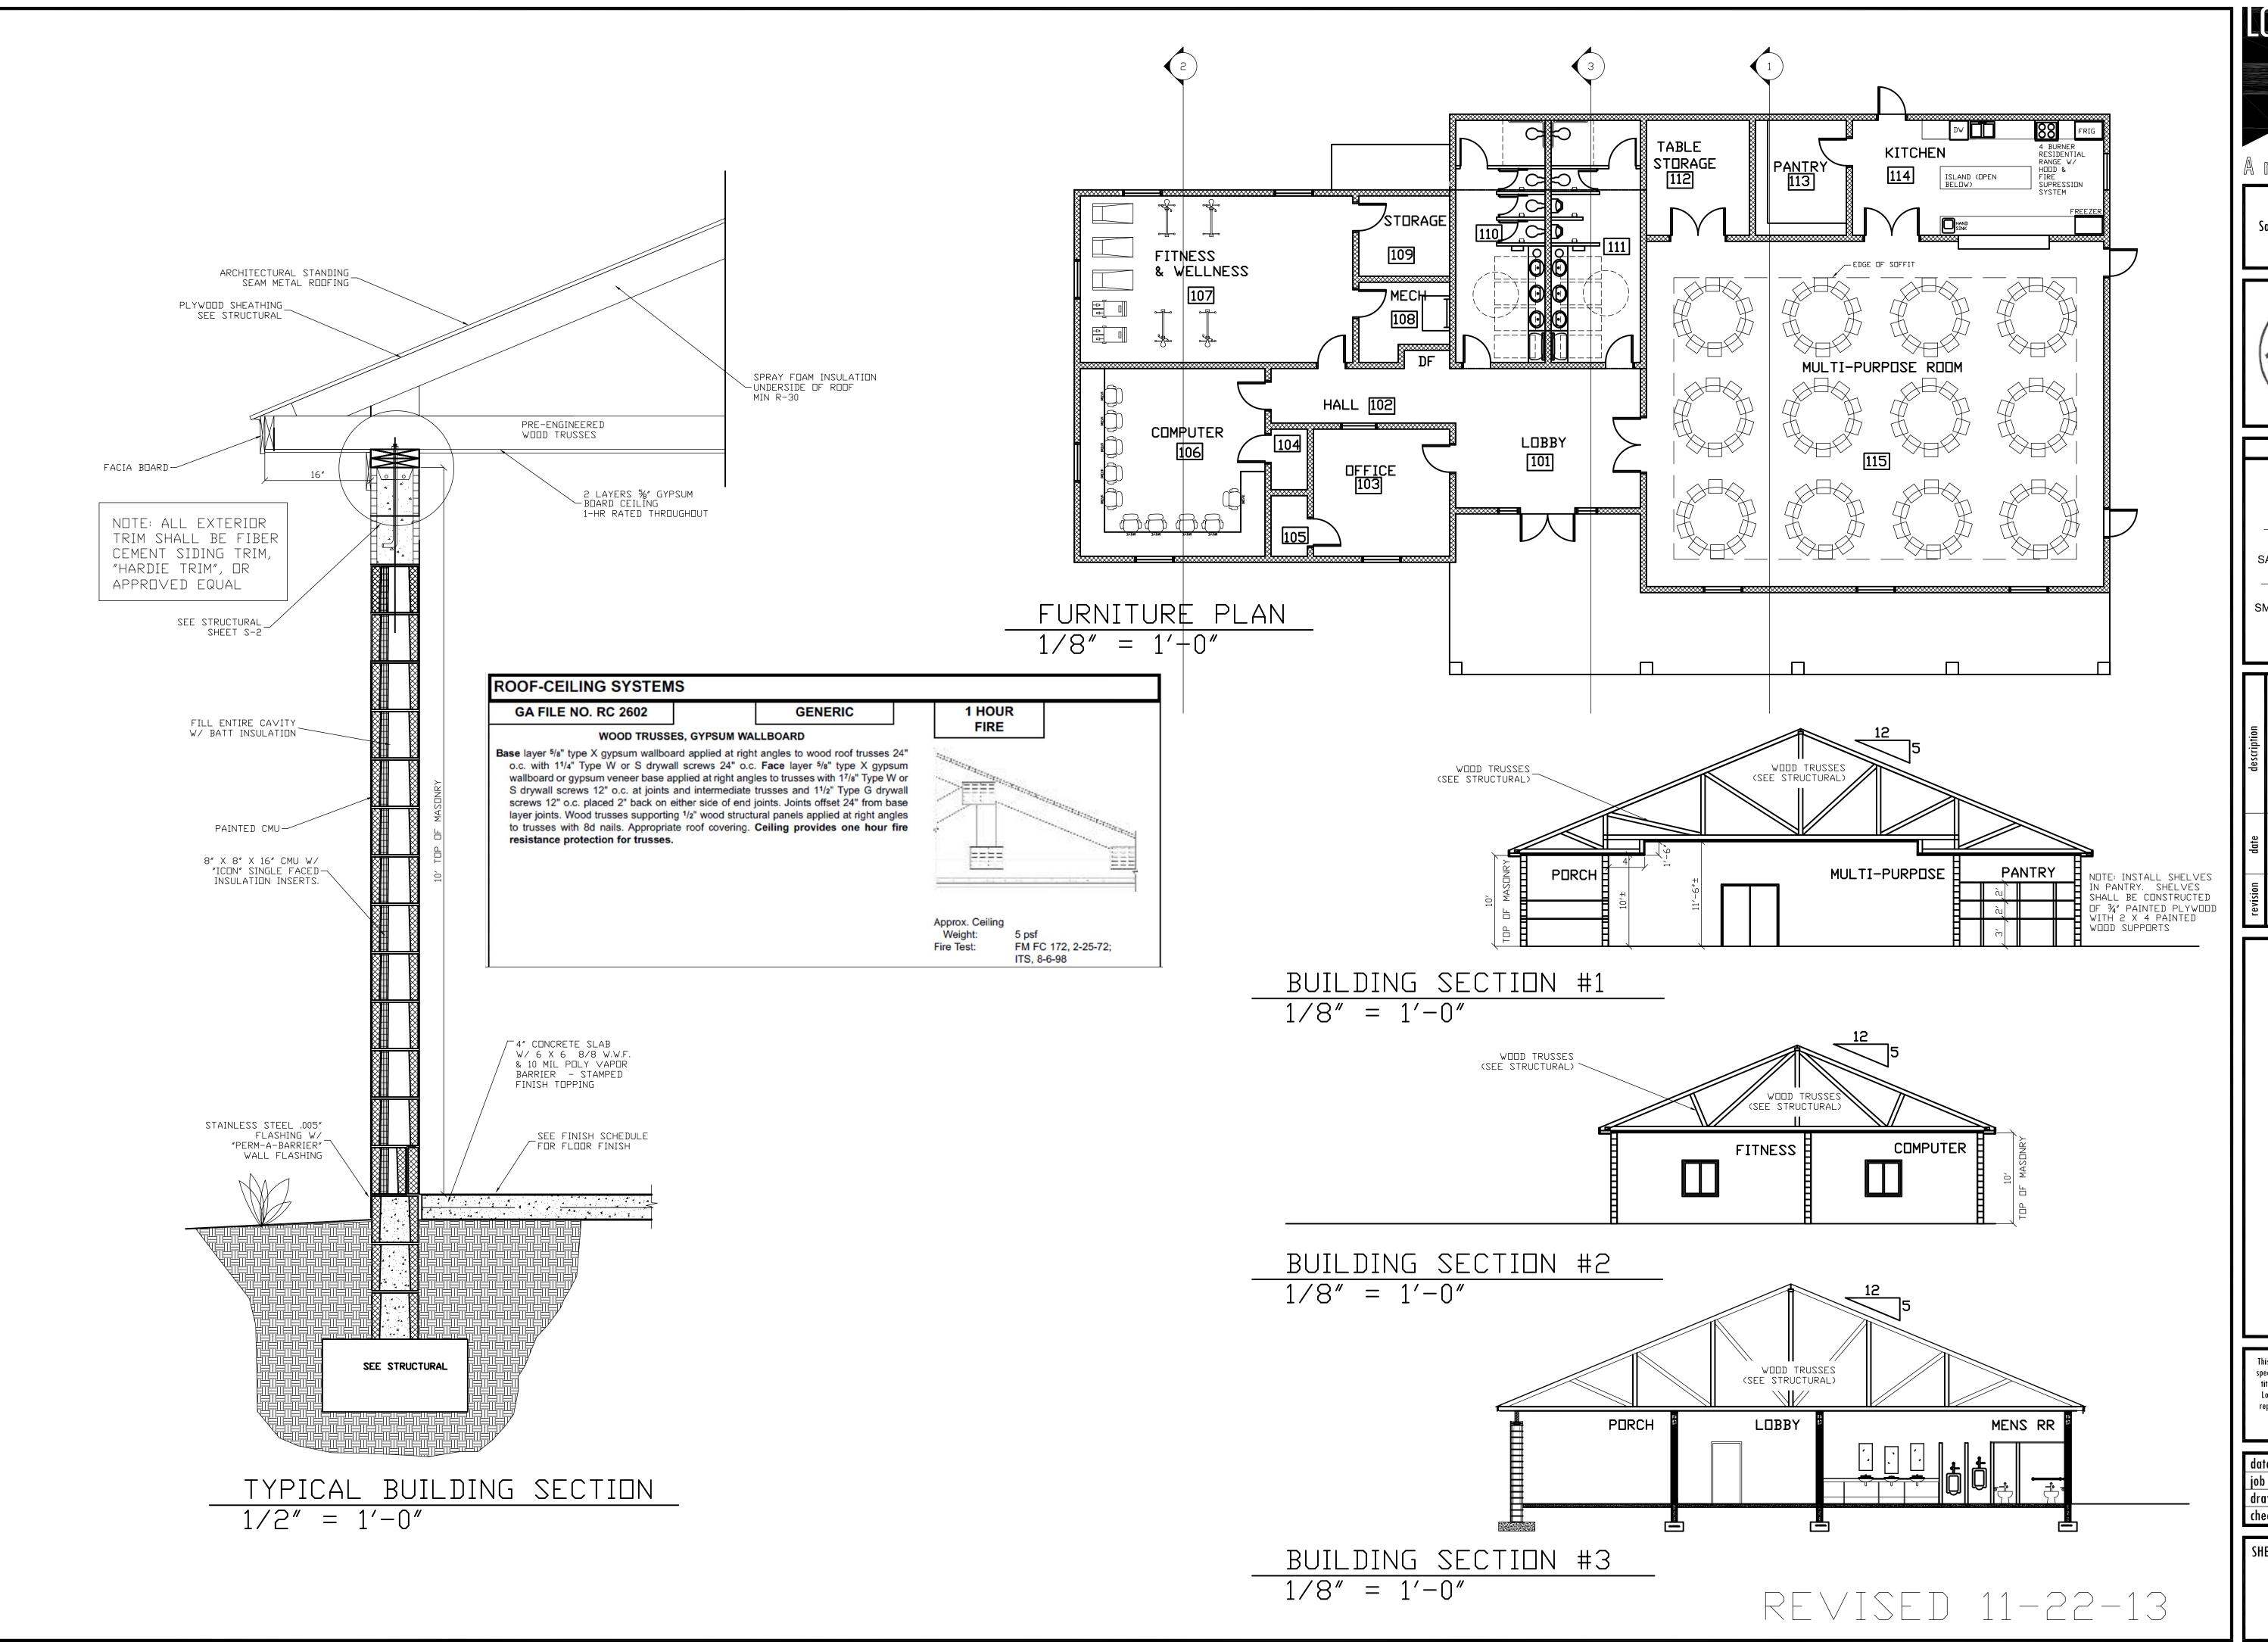
CLOVERDALE
COMMUNITY CENTER
SAVANNAH, GEORGIA


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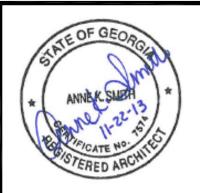
SHEET:

A-2






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consultants: COASTAL CIVIL **ENGINEERING**

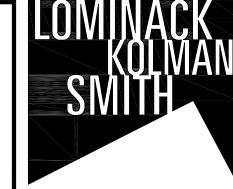SAUSSY ENGINEERING

SMITH & VANDENBULCK **ENGINEERS**



REORGIA GEORGIA CLOVERDAL COMMUNITY CENTE SAVANNAH, GEORG
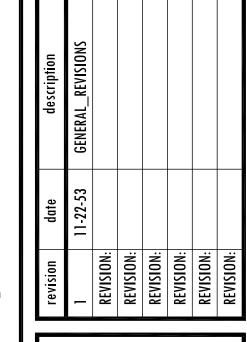
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10/21/13 date: job number: JRK/AKS drawn by: checked by:

SHEET:

A-3

REVISED 11-22-13

4 BURNER RESIDENTIAL
RANGE W/ HOOD & FIRE
SUPRESSION SYSTEM

FOR TRAYS

NOTES/KEY

NOTE #1 = BY MANUFACTURER

Y NOTE #4 = PUSH & PULL & CYLINDER

N ALL HARDWARE SHALL BE ADA COMPLIANT

BB = BALL BEARINGS

N OHE = OVERHEAD EXPOSED

ALUM = ALUMINUM

N |CYL = CLYINDER

N WS = WEATHER STRIP

N = MFR = MANUFACTURER

N = NONE

NOTE #2 = MID-RAIL FLUSH PANIC DEVICE

Y NOTE #3 = SURFACE MOUNTED PANIC DEVICE

1 HOUR RATED FIRE SHUTTER

FREEZER

KITCHEN

KITCHEN PLAN

ELEVATION #4

10′

OPEN TO

WS

Ν

Ν

Ν

Ν

Ν

Ν

MULTI-PURPOSE ROOM

DWR DWR DWR DWR DWR DWR DWR DWR DWR DWR

ELEVATION #2

1/4'' = 1'-0''

LOCKSET | HINGES | CLOSER

6-BB

3-BB

6-BB

6-BB

6-BB

3-BB

3-BB

3-BB

3-BB

3-BB

3-BB 3-BB

3-BB

3-BB

OHE

OHE

OHE

OHE

OHE

OHE

1/4'' = 1'-0''

FREEZE

RATING

N/A

N/A

N/A

N/A

20 MIN

THRESH

ALUM

ALUM

ALUM

ALUM

TRANSITION STRIP

TRANSITION STRIP 20 MIN

1/4'' = 1'-0''

114

 \triangle

FINISH SCHEDULE

LOBBY

HALLWAY

OFFICE

CLOSET

CLOSET

COMPUTER

FITNESS

STORAGE

WOMEN

STORAGE

PANTRY

KITCHEN

MULTI-PURPOSE VCT

LOBBY - MAIN ENTRANCE

115 MULTI-PURPOSE ROOM - SIDE EXIT

114 KITCHEN – REAR EXIT

111 MENS RESTROOM

103 OFFICE

107 FITNESS

103 OFFICE

114 KITCHEN

106

109

106

110 WOMENS RESTROOM

COMPUTER

STORAGE

MECHANICA

COMPUTER

MEN

MECHANICAL

ROOM NO. ROOM NAME

103

104

105

106

107

108

109

110

112

113

SPACE #

DOOR TYPES

1/4'' = 1'-0''

FRAME TYPES

WALL

MAT.

8" CMU BLOCK

DOOR SIZE

3'-0"W X 7'-0"H

3 | 3'-0"W X 7'-0"H

4 3'-0"W X 7'-0"H

11 | 3'-0"W X $\overline{7'-0"H}$

17 3'-0"W X 7'-0"H

1/4'' = 1'-0''

BASE

MAT.

VINYL

CERAMIC TILE

CERAMIC TILE | CERAMIC TILE

CERAMIC TILE

MATERIAL

VCT

DOOR AND FRAME SCHEDULE

SPACE NAME

MULTI-PURPOSE ROOM - SIDE EXIT

MULTI-PURPOSE ROOM - KITCHEN

MULTI-PURPOSE ROOM - FROM LOBBY

MULTI-PURPOSE ROOM - TABLE STORAGE

VIEWER

CEILING

FINISH

PAINTED

DOOR

1 3/4" HM

1 3/4<u>" HM</u>

1 3/4<u>" HM</u>

НМ

НМ

НМ

НМ

1 3/4" HM A

PR 3'-0"W X 7'-0"H | 1 3/4" | ALUM

PR 3'-0"W X 7'-0"H | 1 3/4" | HM

PR 3'-0"W X 7'-0"H 1 3/4"

CERAMIC TILE

CERAMIC TILE

VISION PANEL

FINISH

2 LAYERS 5/8" GYSUM BOARD (TYPE X) PAINTED

2 LAYERS 5/8" GYSUM BOARD (TYPE X) PAINTED

2 LAYERS 5/8" GYSUM BOARD (TYPE X) PAINTED

2 LAYERS 5/8" GYSUM BOARD (TYPE X) | PAINTED

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2 LAYERS 5/8" GYSUM BOARD (TYPE X) | PAINTED

IMPACT/INSULATED

N/A

N/A

N/A

N/A

N/A

N/A

20 MIN

20 MIN

N/A

N/A

N/A

N/A

N/A

THK | MATL | TYPE | GLAZING

HEIGHT

10'-0"

10'-0"

MATL

LALUM

НМ

HM

НМ

НМ

НМ

HM

HM

НМ

НМ

НМ

NOTES

FLOOR TILE 8 X 8, WALL TILE 4 X 4, NOMINAL DIMS

FLOOR TILE 8 X 8, WALL TILE 4 X 4, NOMINAL DIMS

II'-6" 4' SOFFIT AROUND PERIMETER FOR MECHANICAL @ 10'

FRAME

TYPE HEAD

PER MFR

1

DETAIL

JAMB

ISLAND (OPEN BELOW)

NOTE: CONTRACTOR SHALL

INSTALL OWNER PROVIDED APPLIANCES

ELEVATION #3

ELEVATION #1

1/4'' = 1'-0''

1/4'' = 1'-0''

INCLUDING 36" REFRIGERATOR (WITH ICE MAKER),

30" ELECTRIC RANGE, UNDERCOUNTER RESIDENTIAL DISHWASHER, HOOD AND SUPRESSION SYSTEM TO BE PURCHASED AND INSTALLED BY CONTRACTOR.

Lominack/Koli	man/Smith.
date:	10/21/13
job number:	1207
drawn by:	JRK/AKS
checked by:	AKS

date:	10/21/13
job number:	1207
drawn by:	JRK/AKS
checked by:	AKS

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date:	10/21/13
job number:	1207
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date:	10/21/13
job number:	1207
drawn by:	JRK/AKS
checked by:	AKS

Lominack/Kolr	nan/Smith.
date:	10/21/13
job number:	1207
drawn by:	JRK/AKS
checked by:	AKS
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Edininutk/Romani/Jimin.		
date:	10/21/1	
job number:	120	
drawn by:	JRK/AK	
checked by:	AK	

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	date	11-22-13						
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ENGINEERS	

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	escription	REVISIONS				

	consultants:
	COASTAL CIVIL ENGINEERING
	SAUSSY ENGINEERING
	SMITH & VANDENBULCH ENGINEERS


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SAUSSY ENGINEERING

ENGINEERING	
SALISSY ENGINEEDING	

Architects

Post Office Box 1587 Savannah, Georgia, 31402

(912) 232-5561

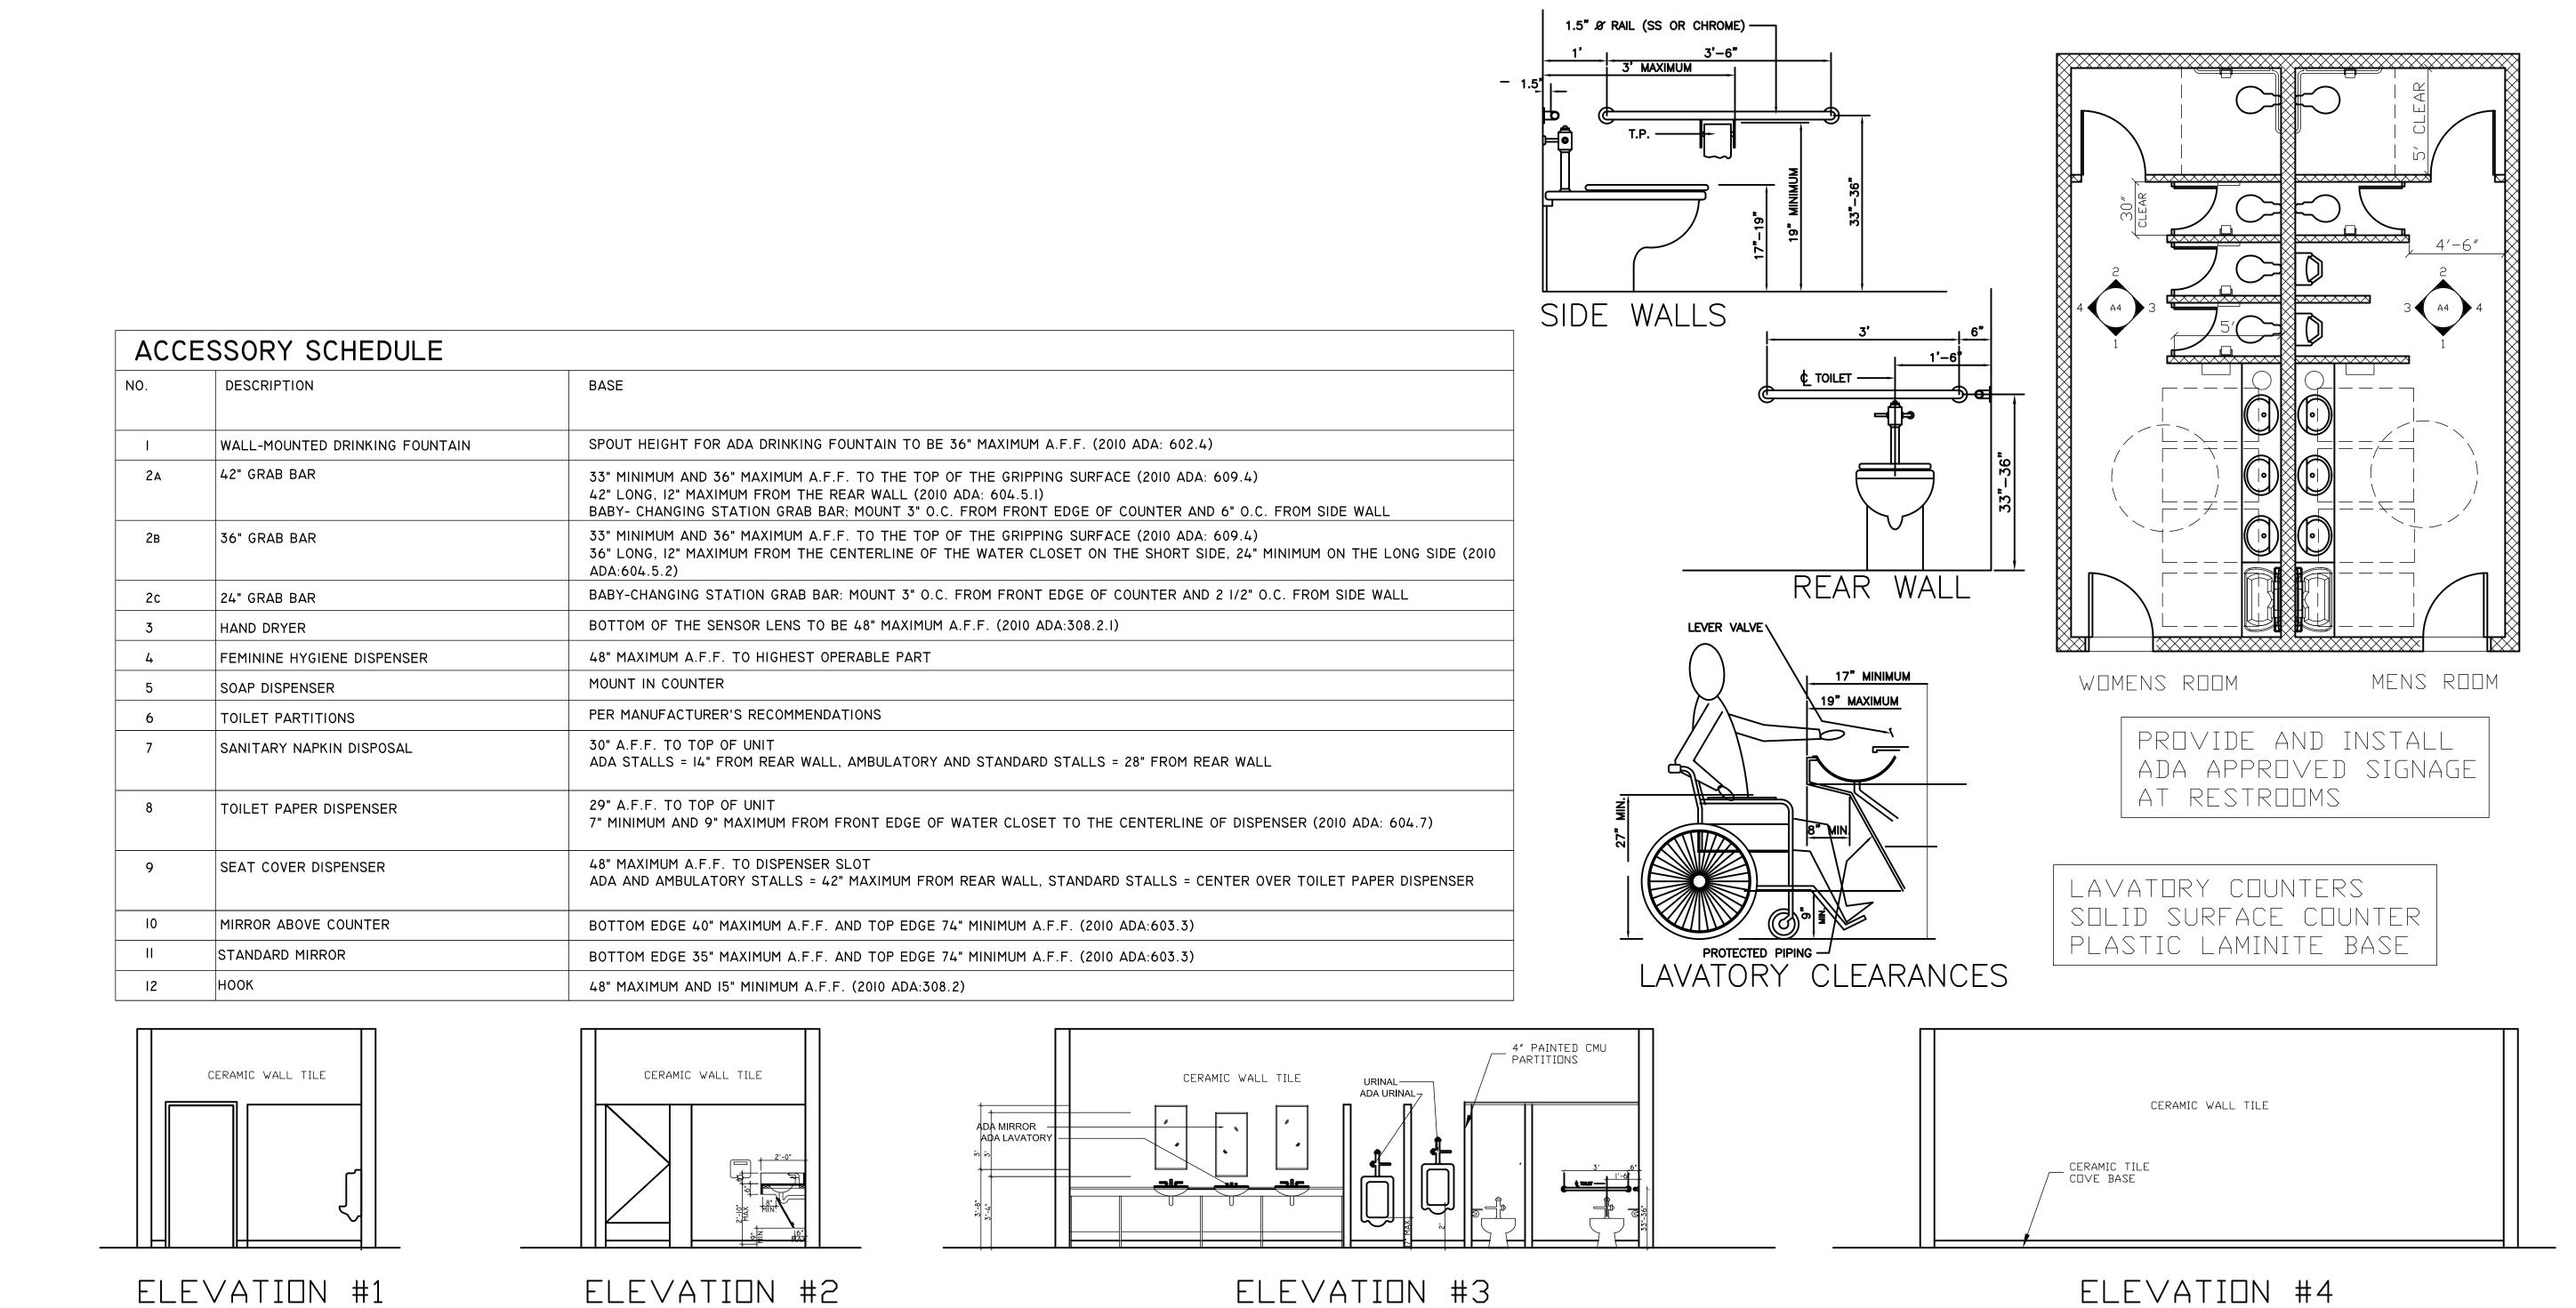

1/4'' = 1'-0''

CERAMIC WALL TILE

MENS RESTROOM ELEVATIONS

ELEVATION #3

WOMENS RESTROOM ELEVATIONS

1/4'' = 1'-0''

4" PAINTED CMU PARTITIONS

ADA MIRROR

1/4'' = 1'-0''

CERAMIC WALL TILE

ELEVATION #1

1/4'' = 1'-0''

1/4'' = 1'-0''

CERAMIC WALL TILE

ELEVATION #2

1/4'' = 1'-0''



1/4'' = 1'-0''

CERAMIC WALL TILE

ELEVATION #4

REVISED 11-22-13

1/4'' = 1'-0''

_ CERAMIC TILE COVE BASE Architects

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consultants:

COASTAL CIVIL ENGINEERING

SAUSSY ENGINEERING

SMITH & VANDENBULCK


ENGINEERS

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date: 10/21/13
job number: 1207
drawn by: JRK/AKS
checked by: AKS

SHEET:

A-5

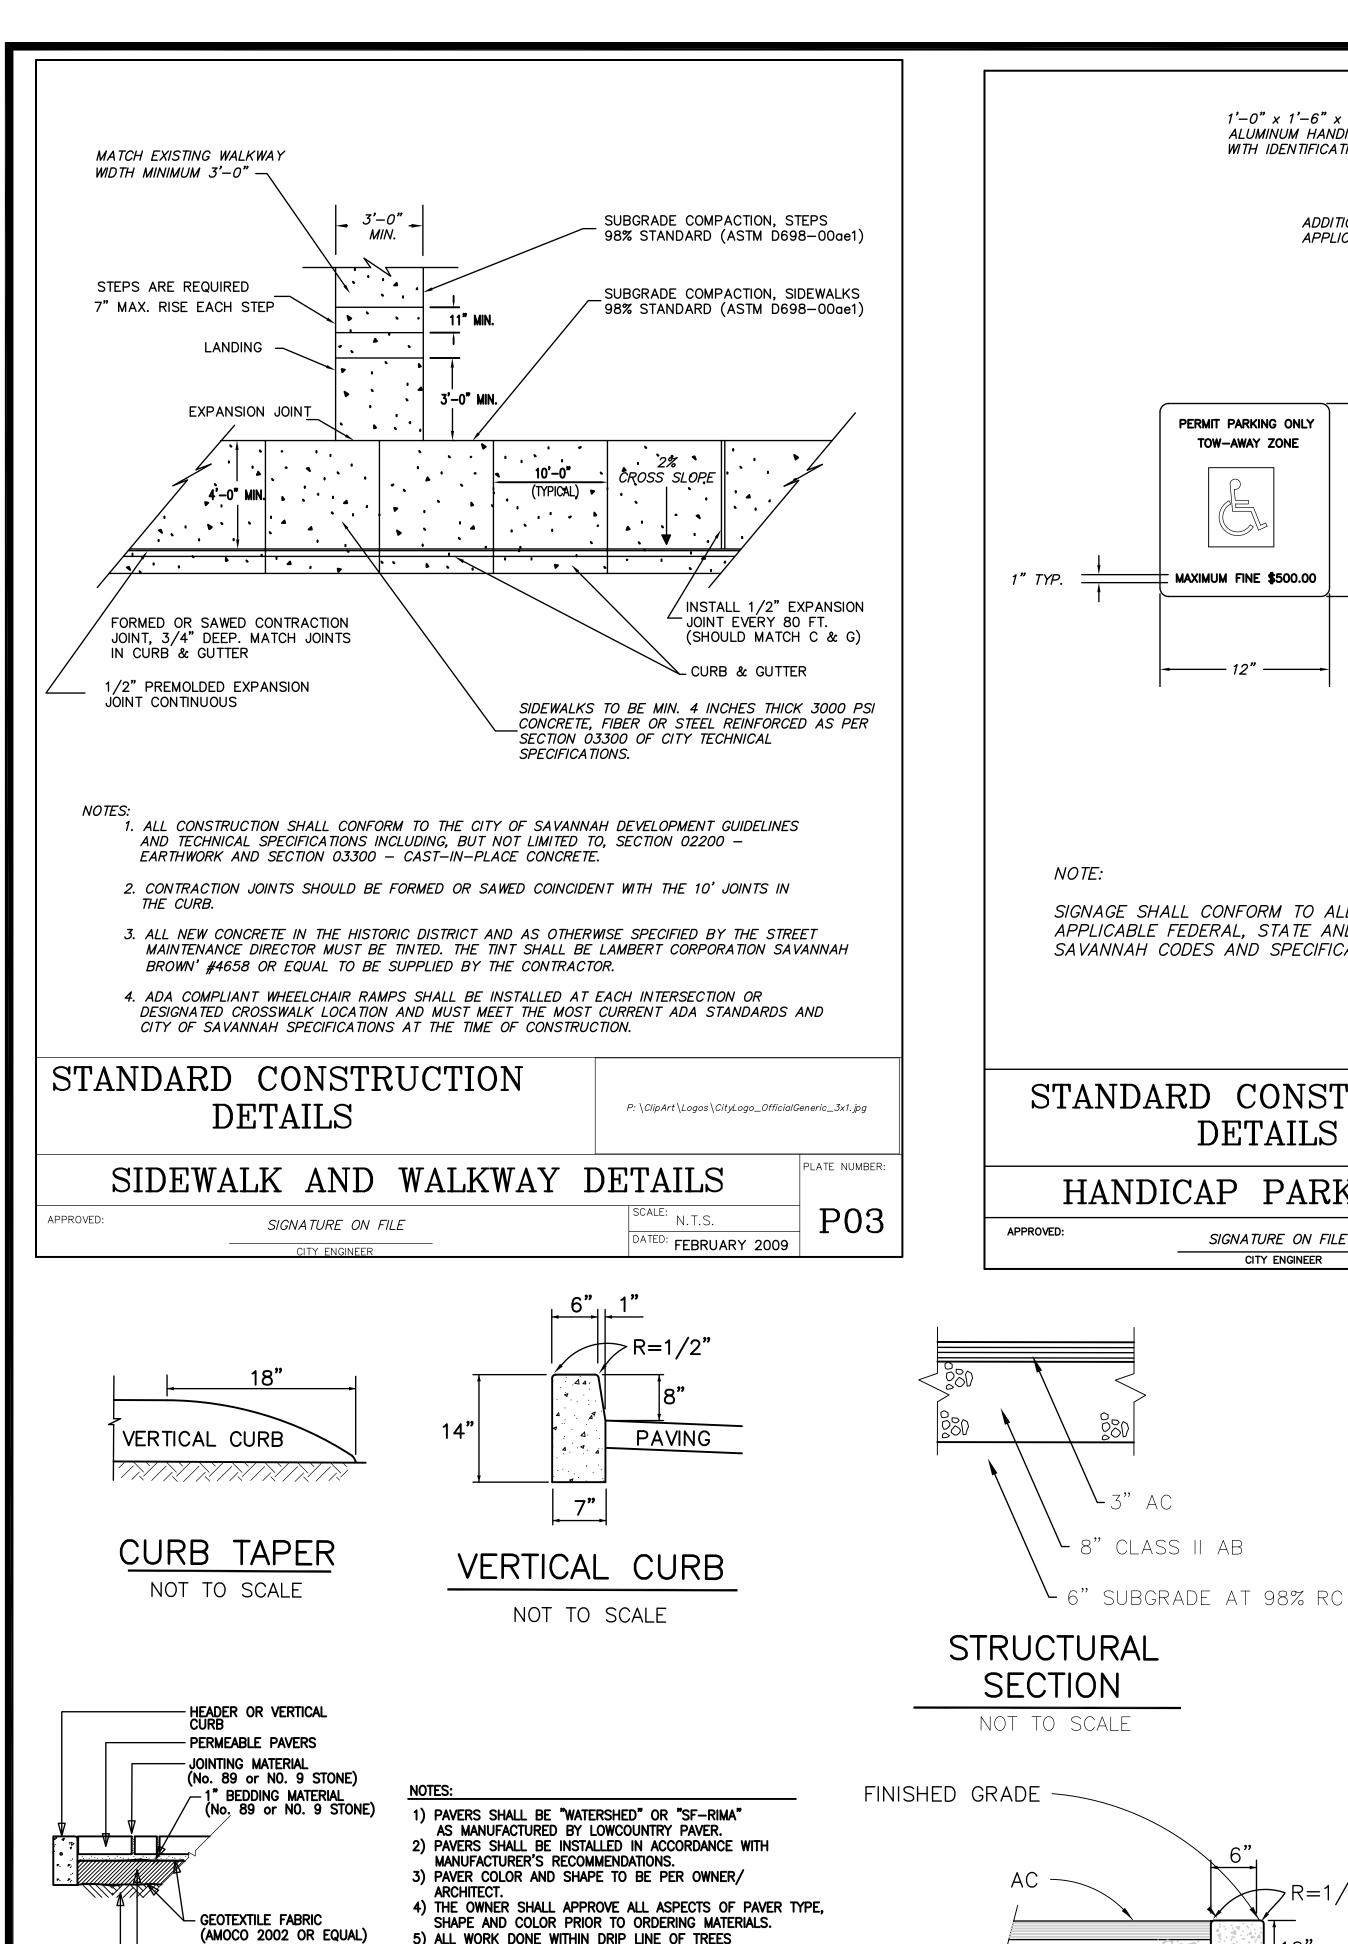

5) ALL WORK DONE WITHIN DRIP LINE OF TREES SHALL BE PERFORMED BY HAND OR LIGHT EQUIPMENT.

BASE COURSE (No. 57 or No. 67 Stone)
COMPACTED TO 95% RC
(12" DEPTH-VEHICULAR AREA)


PERVIOUS PAVERS

NO SCALE

(6" DEPTH-SIDEWALK AREA)

12" SUBGRADE COMPACTED

TO 95% RC

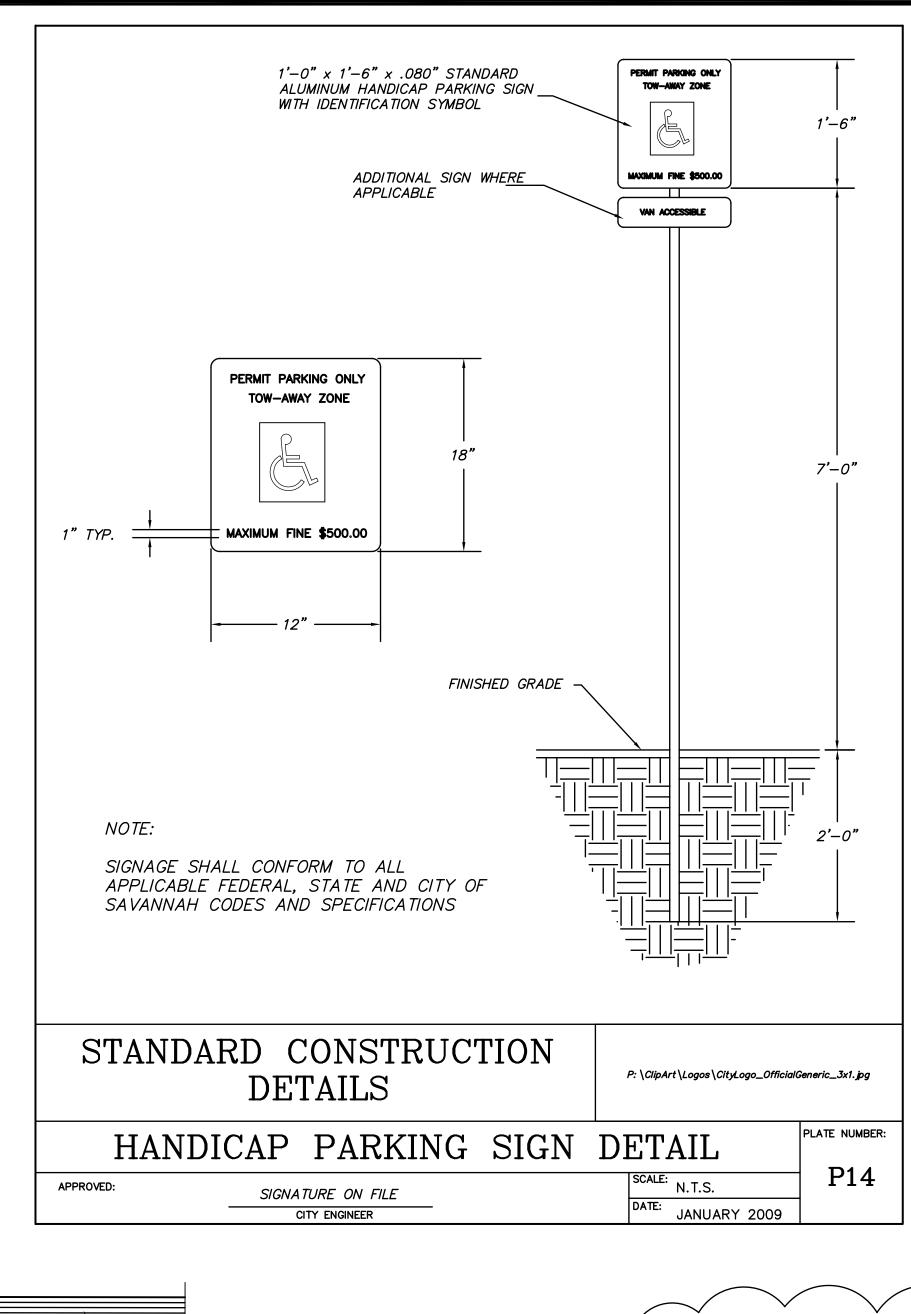



HEADER CURB


NO SCALE

- PCC CURB

AGG. BASE

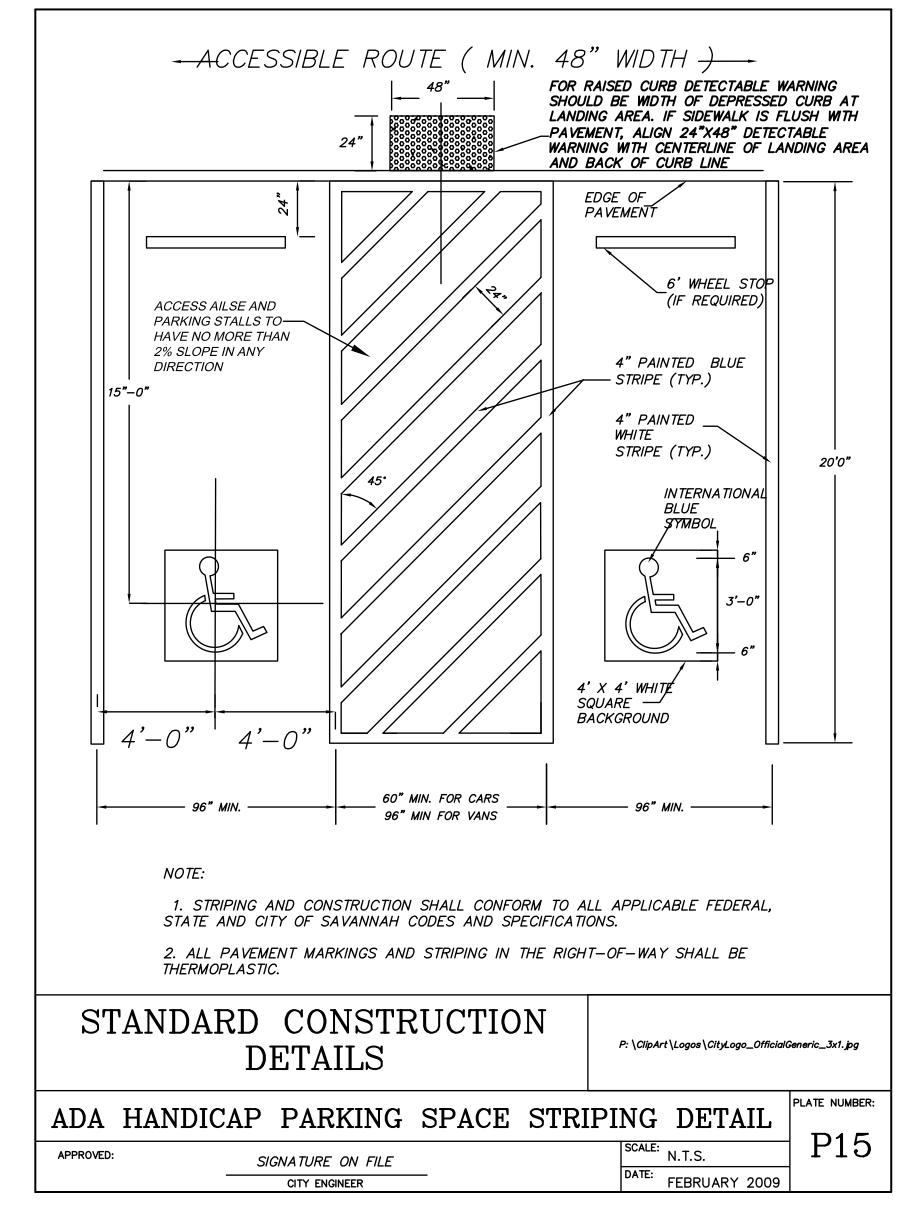

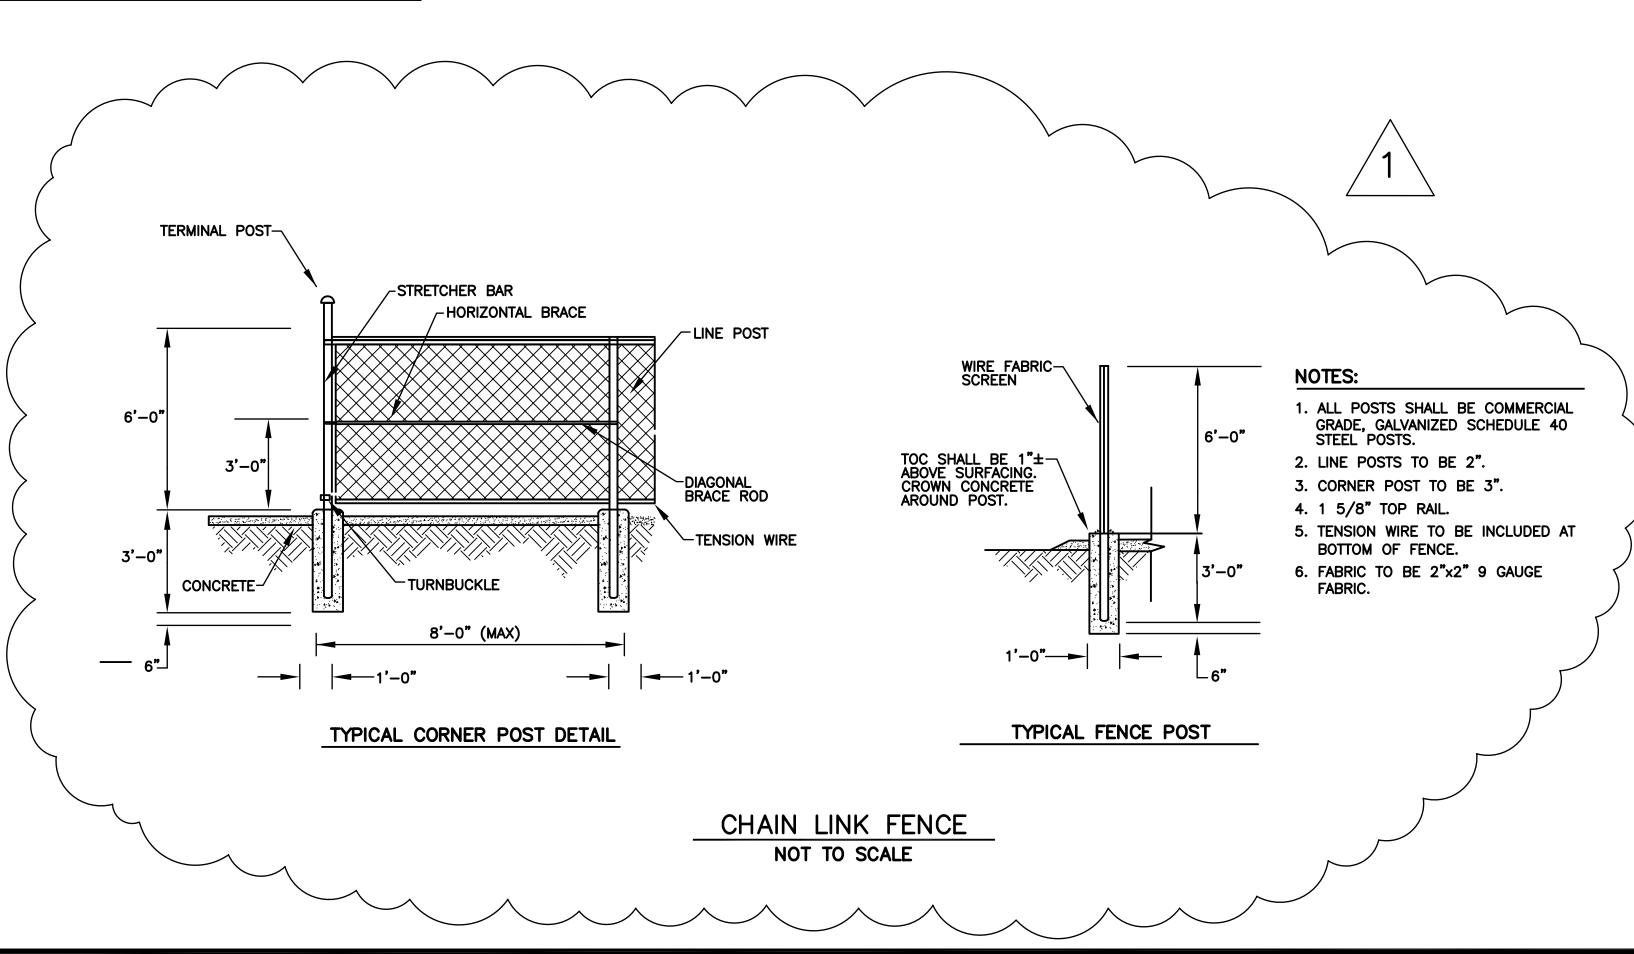


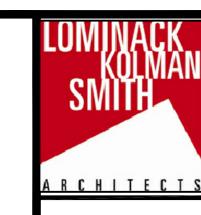

COASTAL

Civil Engineering

Zio East Bay Street Savannah, GA 31401

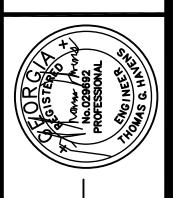

CLOVERDALE COMMUNITY CENTER

EET P.I.N. 2-0070-01-003 SAVANNA

MISCELLANEOUS DETAILS

9 CYNTHIA STREET


DATE
10/16/13

DRAWN BY CHECKED
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DRAWNG NUMBER


DRAWING NUMBER

SUF	RFACE !	MDUNT I	NG, 72	TOTAL SPACES, 1 SECTIONS	WITH	GROUND	BAR		
C. B. N□.	POLES	TRIP AMPS	LOAD KVA	DESCRIPTION	C. B. N□.	POLES	TRIP AMPS	LOAD KVA	DESCRIPTION
1	1	20	1.0	RECEPTACLES - MULTIPURPOSE	2	1	20	1.6	LIGHTING - MULTIPURPOSE
3	1	20	1.0	RECEPTACLES - MULTIPURPOSE	4	1	20	1.6	LIGHTING - MULTIPURPOSE
5	1	20	0.5	RECEPTACLE - EWC	6	1	20	0.4	CEILING FANS
7	1	20	1.0	RECEPTACLES - MULTI, LOBBY, OFFICE	8	1	20	1.3	LIGHTING - KITCHEN, RESTROOMS, STORAGE
9	1	20	1.0	RECEPTACLES – LOBBY, OFFICE, EXT.	10	1	20	1.4	LIGHTING - LOBBY, OFFICE, EQ. DECK
11	1	20	0.6	RECEPTACLES — COMPUTER	12	1	20	1.5	LIGHTING - COMPUTER, FITNESS
13	1	20	0.6	RECEPTACLES — COMPUTER	14	1	20	0.3	LIGHTING — EXTERIOR VIA P/C
15	1	20	0.6	RECEPTACLES — COMPUTER	16	1	20	1.0	RECEPTACLES - FITNESS, EXT., DECK, MULTI
17	1	20	0.6	RECEPTACLES — COMPUTER	18	1	20	0.2	RECEPTACLES — TTB
19	1	20	0.6	RECEPTACLES — COMPUTER	20	1	20	1.0	RECEPTACLES - WOMEN'S RESTROOM
21	1	20	0.6	RECEPTACLES — COMPUTER	22	1	20	1.0	RECEPTACLES - MEN'S RESTROOM
23	1	20	0.5	RECEPTACLES - COMPUTER, FITNESS	24	1	20	1.0	RECEPTACLES - STORAGE, EXT., KITCHEN
25	1	20	1.0	RECEPTACLES - FITNESS	26	1	20	0.3	EF'S
27	1	20	1.0	RECEPTACLES - FITNESS	28	2	50	10.0	RANGE
29	1	20	1.0	RECEPTACLES - FITNESS	30	_	_	_	•
31	1	20	1.0	RECEPTACLES - FITNESS	32	1	20	_	SPARE
33	1	20	1.0	RECEPTACLES - FITNESS	34	1	20	_	SPARE
35	1	20	1.0	RECEPTACLES - FITNESS	36	1	20	_	SPARE
37	1	20	1.0	RECEPTACLES - FITNESS	38	1	20	_	SPARE
39	1	20	1.0	RECEPTACLES - FITNESS	40	1	20	_	SPARE
41	1	20	1.0	RECEPTACLES - FITNESS	42	1	20	_	SPARE
43	1	20	1.5	RECEPTACLES - KITCHEN (SMALL APPLIANCE)	44	1	20	_	SPARE
45	1	20	1.5	RECEPTACLES - KITCHEN (SMALL APPLIANCE)	46	2	60	11.5	AH-1 + 10KW
47	1	20	1.5	RECEPTACLES - KITCHEN (SMALL APPLIANCE)	48	_	_	_	\
49	1	20	1.0	RECEPTACLE - REFRIGERATOR	50	2	50	7.5	CU-1
51	1	20	1.0	RECEPTACLE – FREEZER	52	_	_	_	•
53	1	20	1.0	RECEPTACLES - KITCHEN (SM. APPL., EF-3))	54	2	60	11.5	AH-2 + 10KW
55	1	20	1.5	RECEPTACLES - KITCHEN (SMALL APPLIANCE)	56	_	_	_	₩
57	1	20	1.2	RECEPTACLE — DISHWASHER	58	2	50	7.5	CU-2
59	1	20	1.5	RECEPTACLES - KITCHEN (SMALL APPLIANCE)	60	_	_	_	•
61	1	20	_	SPARE	62	2	60	11.5	AH-3 + 10KW
63	1	20	_	SPARE	64	_	_	_	₩
65	1	20	_	SPARE	66	2	50	7.5	CU-3
67	1	20	-	SPARE	68	-	_	_	\
69	2	20	-	SURGE PROTECTION DEVICE	70	2	30	4.5	WH
71	_	_	_	₩	72	_	_	_	₩

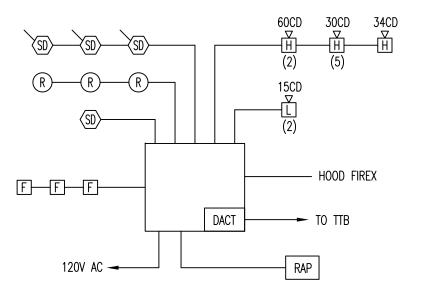



ELECTRICAL LOAD SUMMARY			
LOAD TYPE	CONNECTED (kva)	DEMAND (kva)	
LIGHTING	7.7	7.7	
AIR CONDITIONING	27.0	27.0	
HEATING	30.0	16.0	
WATER HEATER	4.5	4.5	
MISC. POWER	34.2	22.4	
COOKING	10.0	5.0	
TOTAL	113.9	76.6	




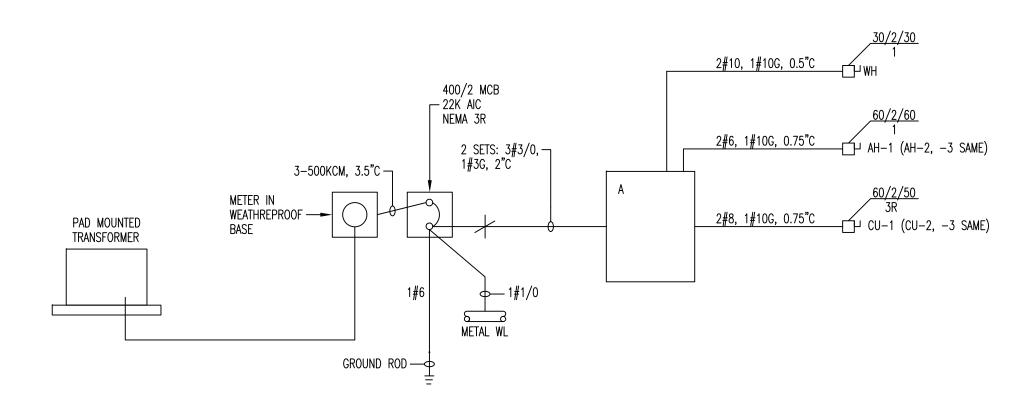





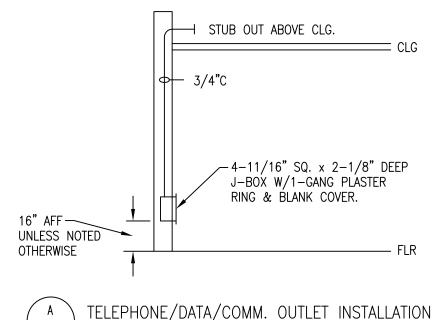

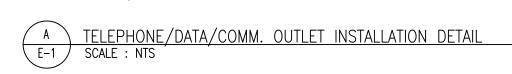


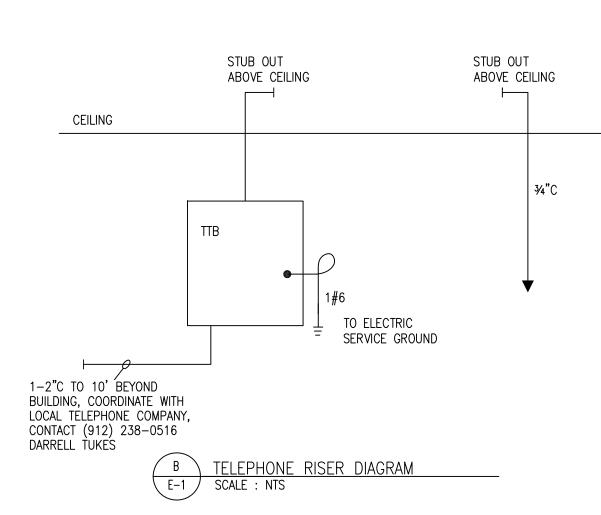

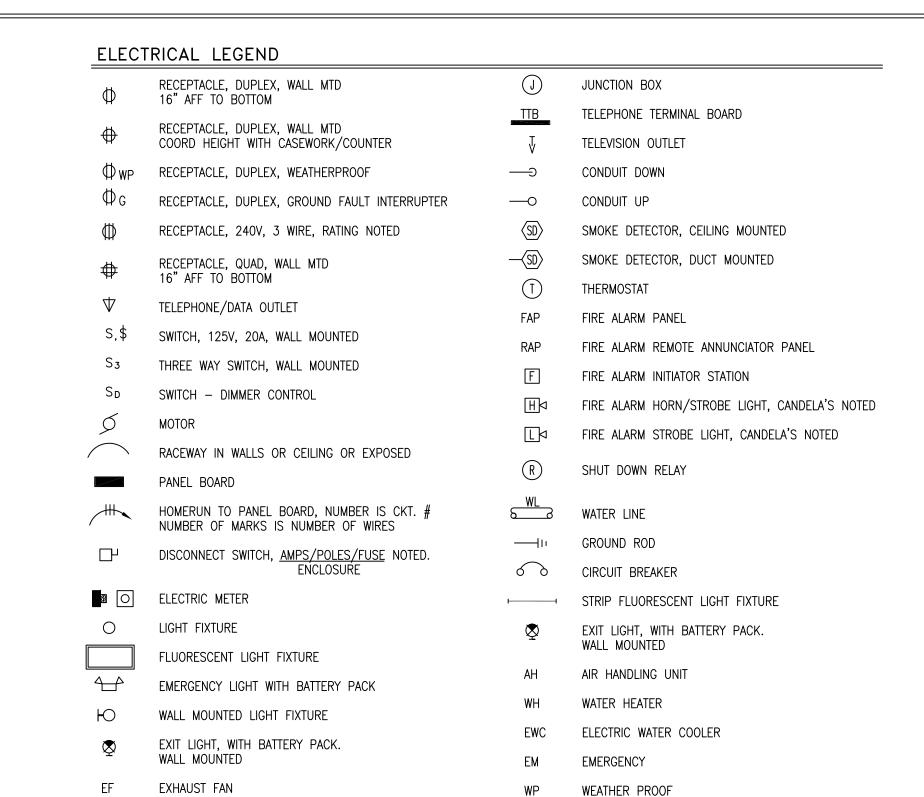

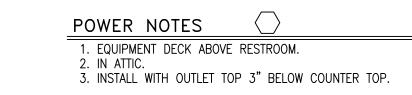

AFF ABOVE FINISHED FLOOR

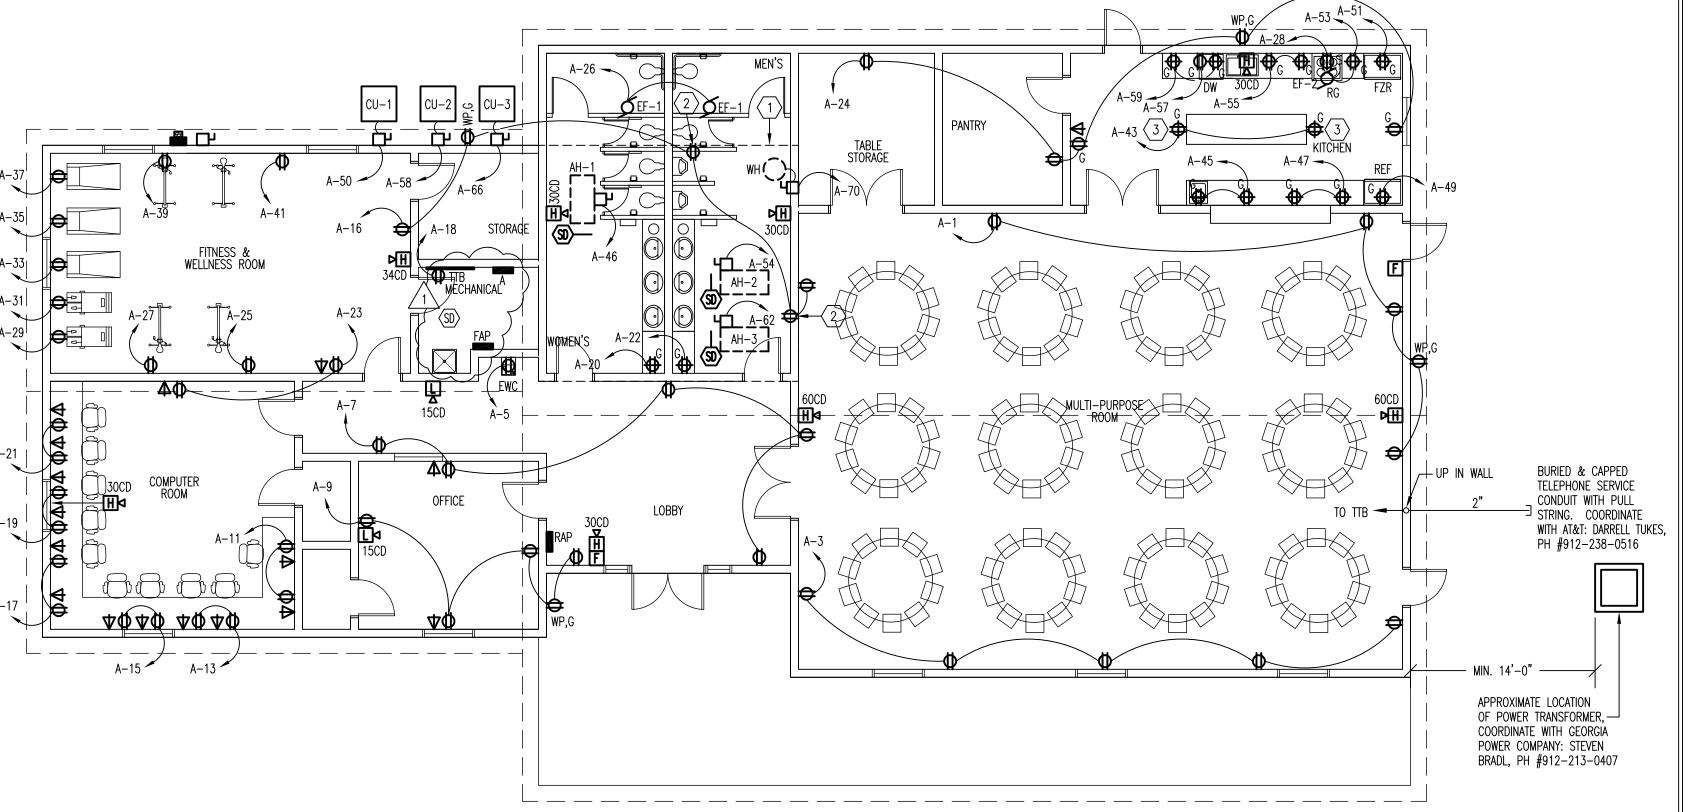

SWITCH W/PILOT LIGHT

PHOTO CONTROL

P/C



SMITH and VANDENBULCK ENGINEERING and LANDSCAPE ARCHITECTURE
A DIVISION OF SAV ENGINEERING, INC. 5 OGLETHORPE PROFESSIONAL BOULEVARD, SUITE 130 SAVANNAH, GEORGIA 31406
PHONE: 912–354–5249 FACSIMILE: 912–352–8429


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DRAWINGS ARE SCHEMATIC. CONTRACTOR IS RESPONSIBLE FOR COORDINATION OF ALL DEVICE LOCATIONS AND INTERCONNECT ROUTING WITH ARCHITECTURAL AND STRUCTURAL CONFIGURATIONS AND REQUIREMENTS.


PROJECT #2012-047

Architects

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consultants:

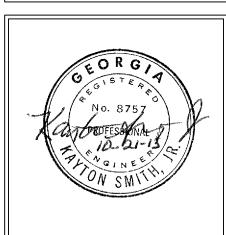


COMMUNITY CENTER 1909 CYNTHIA STREET SAVANNAH, GEORGIA CLOVERDALE

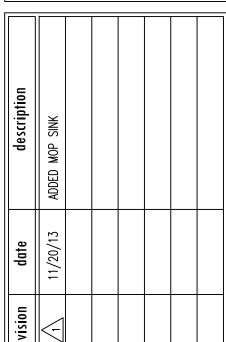
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date:	10/21/13
job number:	1207
drawn by:	LMW
checked by:	KS

SHEET:

- OF: -



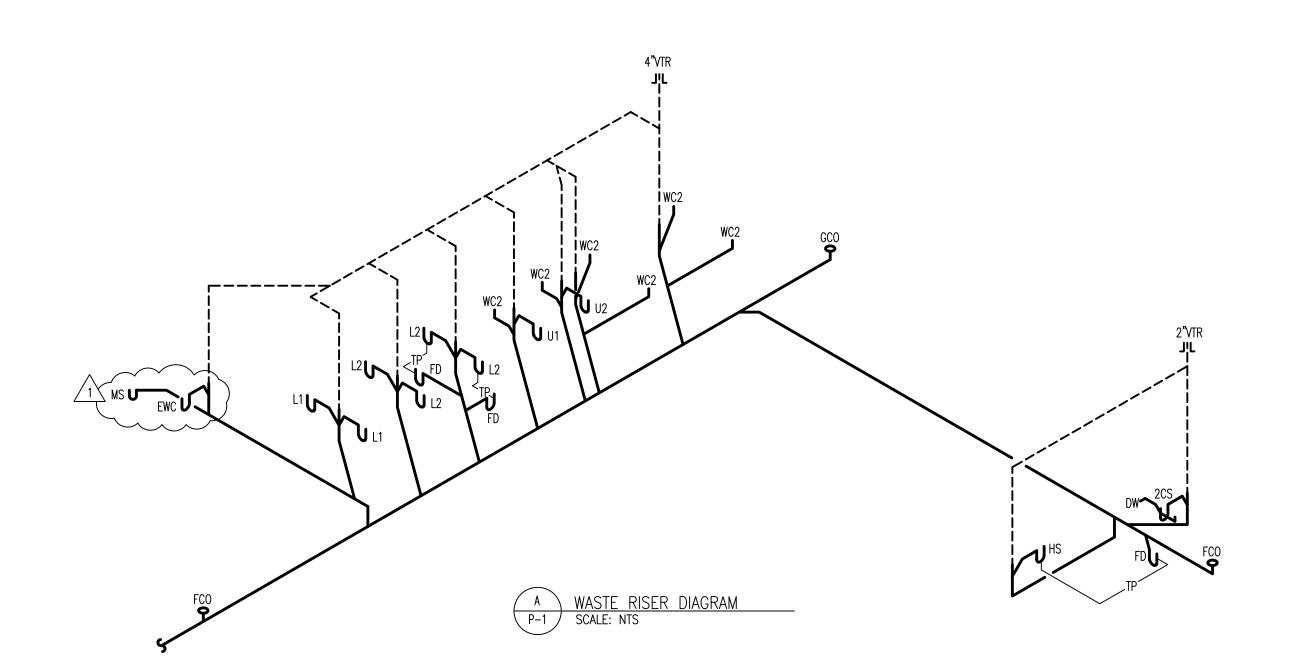

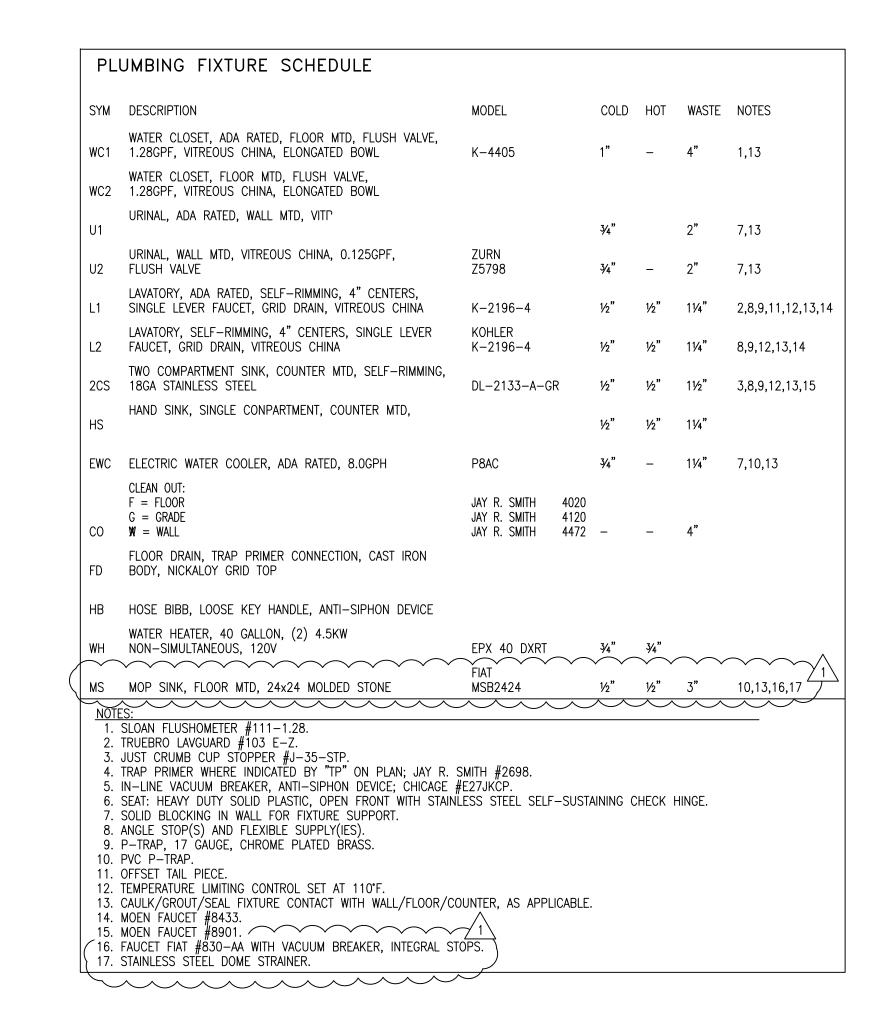OFFICE

FITNESS & WELLNESS ROOM

COMPUTER ROOM

4"VTR WC1 WC1 4" MEN'S

PLUMBING WASTE NOTES 1. INSTALL "TRAP SEAL" IN LIEU OF TRAP PRIMER.

PLUMBING LEGEND

I LOMBINO LE	- OLIVO		
	SAN SEWER	П	WATER HANNER APPECTOR
	SAN VENT	L	WATER HAMMER ARRESTOR PISTON TYPE.
	COLD WATER	WC	WATER CLOSET
	HOT WATER	L	LAVATORY
TP	TRAP PRIMER	EWC	ELECTRIC WATER COOLER
$-\!-\!$	GATE VALVE	SS	SANITARY SEWER
$\overline{\triangleright}-$	CHECK VALVE	VTR	VENT THRU ROOF
	DOUBLE CHECK VALVE	U	URINAL
	BACKFLOW PREVENTER	S	SINK
	PIPE DOWN	WH	WATER HEATER
→ →	PIPE UP PIPE CAP	CO	CLEAN OUT (F=FLOOR,G=GRADE,W=WALL)
 	PIPE TEE	FD	FLOOR DRAIN
_ +	PIPE ELBOW	HD	HUB DRAIN
— нв	HOSE BIBB	AC	ABOVE CEILING
<u></u>	P-TRAP	HS	HAND SINK
—□ P&T	PRESSURE/TEMPERATURE RELIEF VALVE	2CS	TWO COMPARTMENT SINK
		1 MS	MOP SINK



Architects

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consultants:	

description	ADDED MOP SINK			
date	11/20/13			
revision				

	revision	date	
		11/20/13	ADDED MOP S
•			

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date:	10/21/13
job number:	1207
drawn by:	LMW
checked by:	KS

SHEET:

P-1

- OF: -

1 FIRST FLOOR PLAN - PLUMBING WASTE
P-1 SCALE: 1/8" = 1'-0"

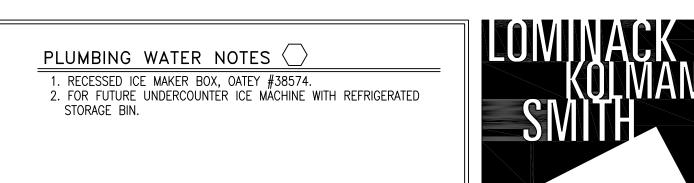
PANTRY

TABLE STORAGE

A DIVISION OF SAV ENGINEERING, INC.
5 OGLETHORPE PROFESSIONAL BOULEVARD, SUITE 130
SAVANNAH, GEORGIA 31406
PHONE: 912-354-5249 FACSIMILE: 912-352-8429 PROJECT #2012-047


SMITH and VANDENBULCK ENGINEERING and LANDSCAPE ARCHITECTURE

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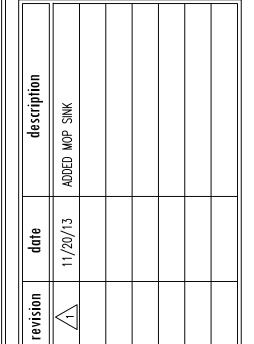


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consultants:



COMMUNITY CENTER 1909 CYNTHIA STREET SAVANNAH, GEORGIA
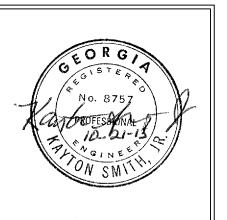
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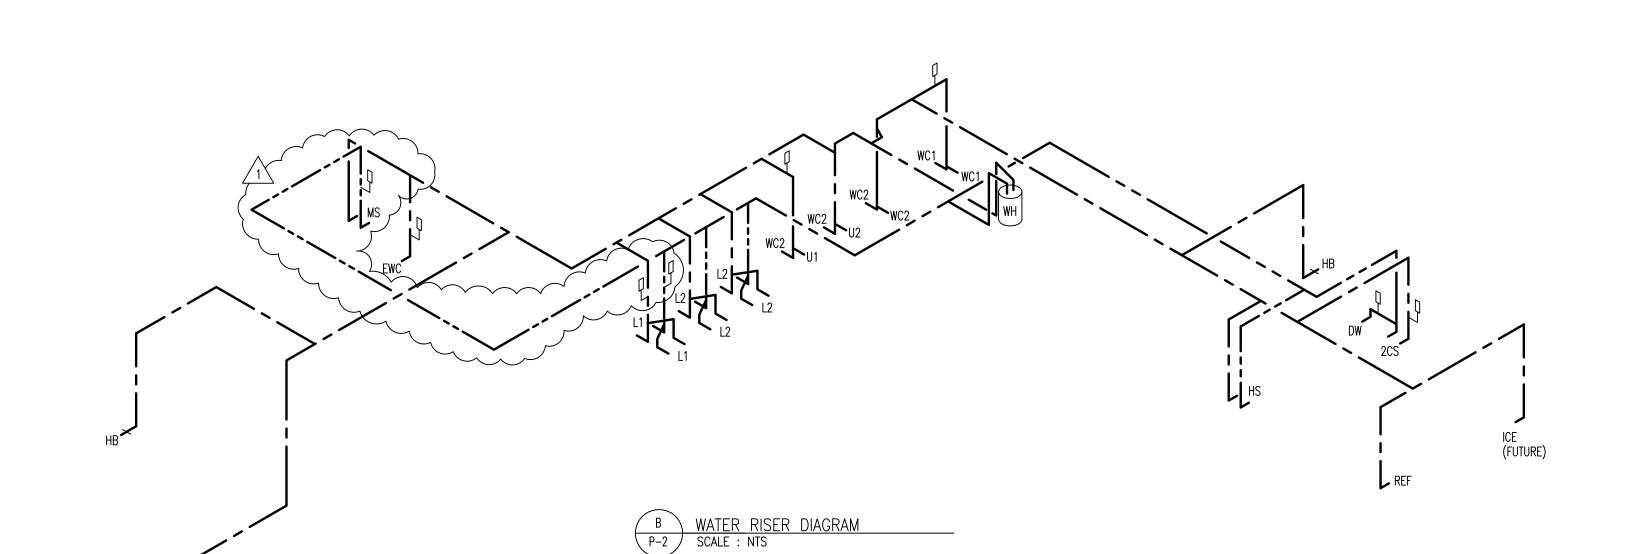
date:	10/21/13
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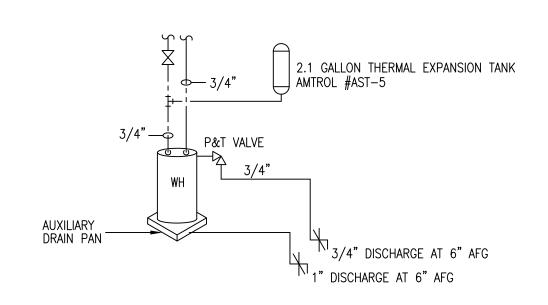
P-2

CLOVERDALE (


SHEET:

- OF: -







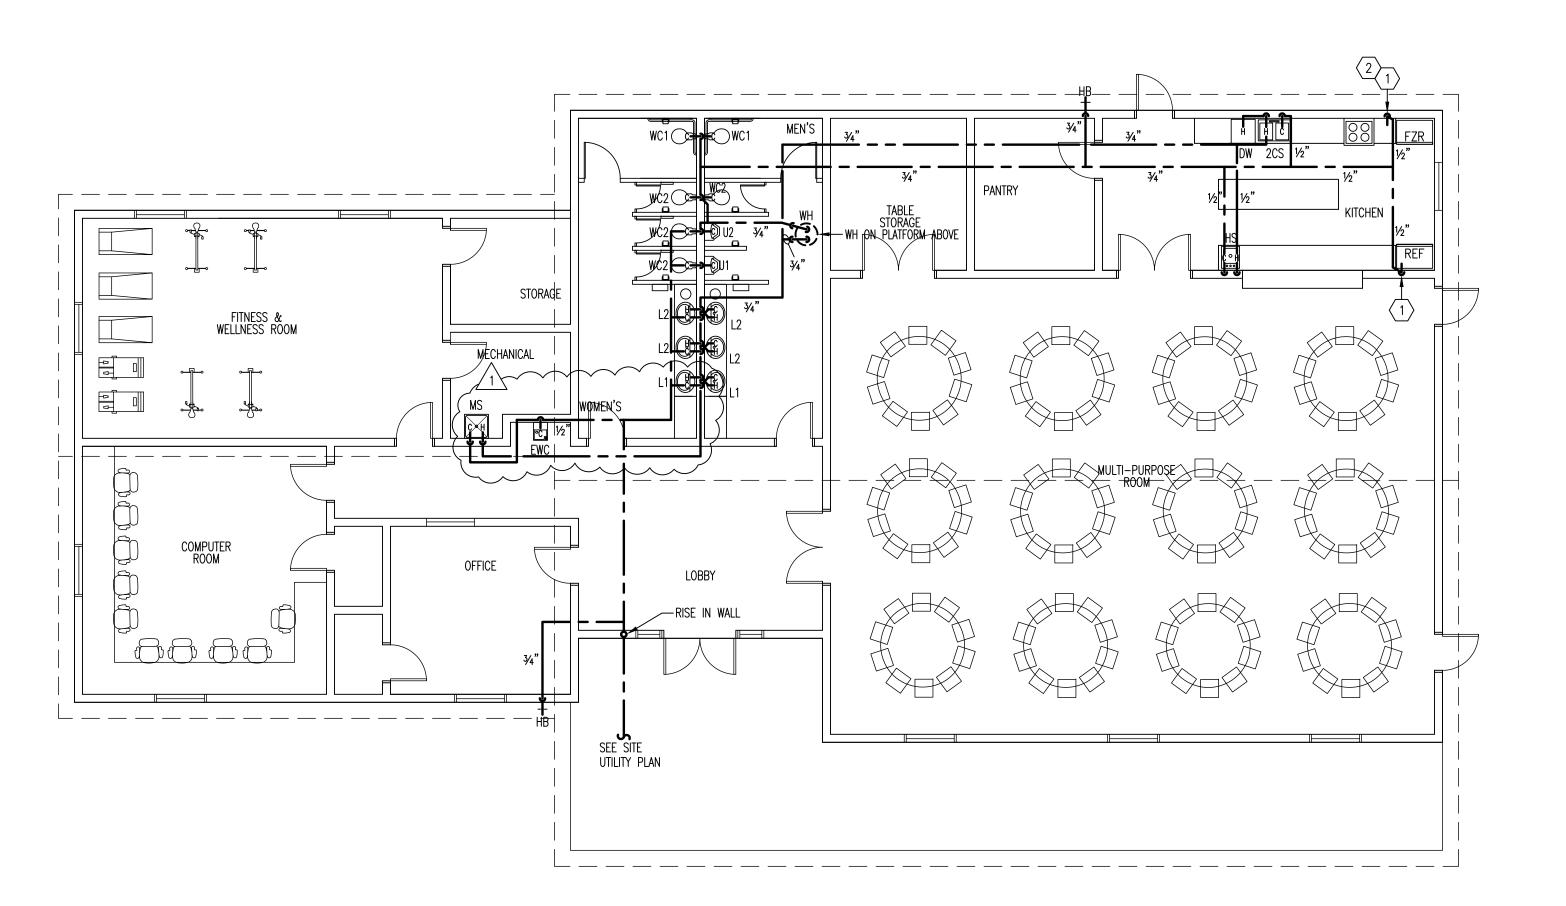

1 FIRST FLOOR PLAN — PLUMBING WATER
P-2 SCALE: 1/8" = 1'-0"

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5 OGLETHORPE PROFESSIONAL BOULEVARD, SUITE 130
SAVANNAH, GEORGIA 31406
PHONE: 912-354-5249 FACSIMILE: 912-352-8429

PROJECT #2012-047

GENERAL NOTE:

DRAWINGS ARE SCHEMATIC. CONTRACTOR IS RESPONSIBLE FOR COORDINATION OF ALL DEVICE LOCATIONS AND INTERCONNECT ROUTING WITH ARCHITECTURAL AND STRUCTURAL CONFIGURATIONS AND REQUIREMENTS.

<u>CLOVERDALE COMMUNITY CENTER</u> PROJECT NUMBER 1207

SECTION 07200 - ICON CMU INSERTS

PART 1 – GENERAL

1.00 RELATED DOCUMENTS

- A. Drawings and general provisions of the Contract, including General and Supplementary Conditions and Division 1 Specification Sections, apply to this Section.
- B. Section 4200 Unit Masonry

1.01 SUMMARY

A. Section provides for pre-installed individually molded, single face, compression-fit, expanded polystyrene insulation inserts for concrete masonry units.

1.02 REFERENCES

- A. American Society for Testing and Materials
 - 1. ASTM C 578-91 Specification for Rigid Cellular Polystyrene Thermal Insulation
 - 2. ASTM C 272 Standard Test Method for Water Absorbtion of Core Materials for Structural Sandwich Constructions
 - 3. ASTM E 84 Flame Spread Characteristics
 - 4. ASTM C 303 Test Method for Density of Preformed Block-type Thermal Insulation

1.03 SUBMITTALS

- A. Product Data: Spec-Data[©] Sheet and installation procedures.
- B. Test Reports: Wall system thermal performance test data, Building Code Listings, and other applicable testing by independent testing laboratories which are available on request from Grace Construction Products.
- C. Certification of compliance with Performance Requirements.

1.04 WARRANTY

A. Warrant that Icon inserts are free of defects and are manufactured to meet physical properties and material specifications.

PART 2 - PRODUCTS

2.01 MATERIALS

- A. Description: Inserts complying with ASTM C 578-91; Standard Type I.
- B. Performance Requirements:
 - 1. Moisture Absorption: ASTM C 272 < 2.0% by volume
 - 2. Flame Spread Characteristics: ASTM E 84 Flame Spread 5; Smoke Developed-40.

ICON CMU INSERTS 07200-1

Icon® Concrete Masonry Unit Insulation

- 3. Insulation Characteristics: Total R-Value = $1.03 \text{ m}^2 \cdot \text{K/W}$ (5.83), and U-Value = $.97 \text{ W/(m}^2 \cdot \text{k})$ (0.17) for 203 mm (8") CMU [density 1682 kg/m³ (105 lbs.)] with insert installed.
- 4. Drainage: Allows full drainage of water in cores of masonry units.
- 5. Rot & Vermin Resistance: Produced from expanded polystyrene fully resistant to rot; does not attract vermin, termites or rodents.
- 6. Density: ASTM C $303 14.4 \text{ kg/m}^3$ to 18.3 kg/m^3 (0.90 to 1.3 lb./cu. ft.)
- 7. Components: Insulation shall contain no fluorocarbons and no formaldehyde.
- 8. Shape: Compressable insert allowing tight fit with inside faces of both webs of the CMU core, placed adjacent to the face of the block indicated on the Construction Documents.
- C. Product: Icon® single face inserts manufactured by Concrete Block Insulating Systems & available from Grace Construction Products.

PART 3 - EXECUTION

3.01 EXAMINATION

A. Examine conditions, with installer present, for compliance with requirements for installation tolerances and other specific conditions, and other conditions affecting performance of unit masonry.

3.02 INSTALLATION

- A. General: Inserts shall be pre-installed by CMU manufacturer prior to delivery to jobsite.
- B. Unless otherwise indicated on Construction Documents, inserts shall be left in place when grouting.

End of Section

ICON CMU INSERTS 07200-2

<u>CLOVERDALE COMMUNITY CENTER</u> PROJECT NUMBER 1207

SECTION 07610 - SHEET METAL ROOFING

PART 1 - GENERAL

1.1 SUMMARY

- A. Section Includes:
 - 1. Aluminum roofing.
 - 2. Underlayment.
 - 3. Flashings, trim, and accessories.

B. Related Sections:

. Division 01: Administrative, procedural, and temporary work requirements.

1.2 REFERENCES

- A. American Society of Civil Engineers (ASCE) 7 Minimum Design Loads for Buildings and Other Structures.
- B. ASTM International (ASTM):
 - 1. A755/A755M Standard Specification for Steel Sheet, Metallic Coated by the Hot-Dip Process and Prepainted by the Coil-Coating Process for Exterior Exposed Building Products.
 - 2. B117 Standard Practice for Operating Salt Spray (Fog) Apparatus.
 - 3. D523 Standard Test Method for Specular Gloss.
 - 4. D1308 Standard Test Method for Effect of Household Chemicals on Clear and Pigmented Organic Finishes.
 - 5. D2247 Standard Practice for Testing Water Resistance of Coatings in 100% Relative Humidity.
 - 6. D2794 Standard Test Method for Resistance of Organic Coatings to the Effects of Rapid Deformation (Impact).
 - 7. D3359 Standard Test Methods for Measuring Adhesion by Tape Test.
 - 8. D3363 Standard Test Method for Film Hardness by Pencil Test.
 - 9. E84 Standard Test Method for Surface Burning Characteristics of Building Materials.
 - E1592 Standard Test Method for Structural Performance of Sheet Metal Roof and Siding Systems by Uniform Static Air Pressure Difference.
 - 11. G53 Practice for Operating Light- and Water-Exposure Apparatus (Fluorescent UV-Condensation Type) for Exposure of Nonmetallic Materials.

1.3 SYSTEM DESCRIPTION

- A. Design Requirements; design roof system to withstand:
 - 1. Live and dead loads in accordance with Building Code.
 - 2. Minimum wind pressures in accordance with Building Code, tested in accordance with ASTM E1592.
 - 3. Movement caused by an ambient temperature range of 120 degrees F and a surface temperature range of 160 degrees F.

1.4 SUBMITTALS

- A. Submittals for Review:
 - 1. Shop Drawings: Include dimensioned layout showing locations of seams, accessories, gage of metal, fastening methods, provisions for expansion and contraction, and details of joints.
 - 2. Samples: Each profile proposed for use.

SHEET METAL ROOFING 07610-1

1.5 PROJECT CONDITIONS

- A. Do not apply underlayment at ambient or surface temperatures less than 40 degrees F or on wet or frozen substrate.
- B. Do not install roofing on wet or frozen substrate.

1.6 WARRANTIES

- A. Furnish manufacturer's 20 year warranty providing coverage against water leakage through roofing system. Include roof panels and side seams, panel end laps, roof-to-wall flashings, ridge flashings, hip flashings, valley flashings, high-side eave flashings, rake flashings, expansion joint flashings, and manufacturer-approved curb and penetration flashings.
- B. Furnish manufacturer's 25 year, 6 month limited warranty providing coverage against rupture, structural failure, or perforation of acrylic-coated aluminum-zinc alloy coated steel sheet due to corrosion.
- C. Furnish manufacturer's 35-year limited warranty providing coverage against chipping, cracking, peeling, flaking, or checking of PVDF-coated [aluminum-zinc alloy coated steel] [aluminum] sheet.

PART 2 - PRODUCTS

2.1 MATERIALS

- A. Aluminum Sheet:
 - 1. ASTM B209, alloy 3105, temper H14, H22, or H24, [0.032] [0.040] [0.050] [0.063] inch thick.

2.2 ACCESSORIES

- A. Underlayment: As recommended by the manufacturer.
- B. Panel Clips: Stainless steel, thermally responsive.
- C. Fasteners: Same material and finish as sheet metal, with neoprene gasketed washers where exposed.
- D. Underlayment Fasteners: Hot dip galvanized steel, length to penetrate minimum 3/4 inch into sheathing.
- E. Joint Sealers: As recommended by the manufacturer.
- F. Touch-Up Pens: CoolR touch up pens provided my manufacturer in color to match panel finish.

2.3 FINISHES

- A. Panels and Trim: ASTM A755/A755M; CoolR fluoropolymer coating applied to sheets in coil form, <u>Colonial</u> Red color.
- B. Panels and Trim: ASTM A755/A755M; CoolR fluoropolymer coating applied to sheets in coil form, <u>Colonial</u> Red color.
- C. Coating Performance Requirements:
 - 1. Specular gloss: 25 to 35 at 60 degrees; tested to ASTM D523.
 - 2. Abrasion resistance: Total 67 liters sand plus or minus 10 liters; tested to D968.
 - Acid resistance: Tested to D1308.
 - a. 10 percent hydrochloric acid at 24 hours: No visible change.
 - b. 20 percent hydrochloric acid at 18 hours: No visible change.
 - c. 20 percent sulfuric acid at 18 hours: No visible change.
 - d. 25 percent sodium hydroxide at 1 hour: No visible change.
 - e. 20 percent muriatic acid at 15 minutes: No visible change.

Sheet Metal Roofing 07 6100-2

- 4. Humidity resistance: 3000 hours, Rating 10, no blisters; tested to D2247.
- 5. Impact resistance: 3.0 times metal thickness in inch-pounds without loss of adhesion; tested to D2294.
- 6. Adhesion: No loss of adhesion; tested to ASTM D3359.
- 7. Pencil hardness: Hb minimum; tested to ASTM D3363.
- 8. Surface burning characteristics: Class A; tested to ASTM E84.
- 9. Accelerated weathering: 2000 hours, No. 8 chalk, Color 2 E; tested to ASTM G53.
- 10. Formability: 1/8 inch madrel, no cracking or loss of adhesion; tested to ASTM D522.
- Salt spray resistance: 1000 hours, Scribe 7, 1/16 inch blisters, Field 10, no blisters; tested to ASTM B117.
- D. Panels and Trim: High-performance clear acrylic coating.

PART 3 - EXECUTION

3.1 INSTALLATION OF UNDERLAYMENT

- A. Starting at low edge, apply one 18 inch wide strip of underlayment horizontally over substrate. Apply following strips full 36 inch width; weatherlap preceding strip by 19 inches so that not less than two plies cover substrate at any point.
- B. Lap ends 6 inches minimum.
- C. Fasten top of each strip under overlapping strip to hold strip in position until roofing is installed.
- D. Provide 18 inch weave pattern at valleys.
- E. Lap underlayment minimum 12 inches over hips and ridges from both sides. Apply 36 inch wide strip centered lengthwise over ridge. Nail at 12 inches on center on each side.
- F. Extend minimum 4 inches up abutting vertical surfaces.

3.2 INSTALLATION OF ROOFING

- A. Fabricate roofing panels using approved roll forming equipment.
- B. Form roofing to provide 1-1/2 inch high standing seams spaced nominally 18 inches on center.
- C. Form panels in single lengths from eave to ridge.
- D. Form sections true to shape, accurate in size, square, and free from distortion and defects.
- E. Apply roofing panels beginning at low edge of roof.
- F. Panel end joints not permitted.
- G. Fit flashings with square corners and surfaces true, aligned, and accurate to required profiles.
- H. Fasten panels to supports using concealed panel clips. Exposed fasteners permitted on trim members only.
- I. Install trim to maintain visual continuity of system.
- J. Install joint sealers and gaskets to prevent water penetration.
- K. Flash penetrations through roofing with metal trim to match panels:
 - 1. Lap flashings over roof panels 12 inches minimum on all sides and seal with double bead of joint sealer.
 - 2. Install metal draw band and joint sealer at top of pipe penetrations.
 - 3. Install water diverter at uphill side of square and rectangular penetrations.
- L. Installation Tolerances:
 - 1. Variation from location: Plus or minus 1/4 inch.

Sheet Metal Roofing 07 6100-3


2. Variation from plane: 1/4 inch in 10 feet.

3.3 ADJUSTING

A. Touch up field cuts and abrasions to match factory finish using touch-up pens.

END OF SECTION 07 6100

Sheet Metal Roofing 07 6100-4

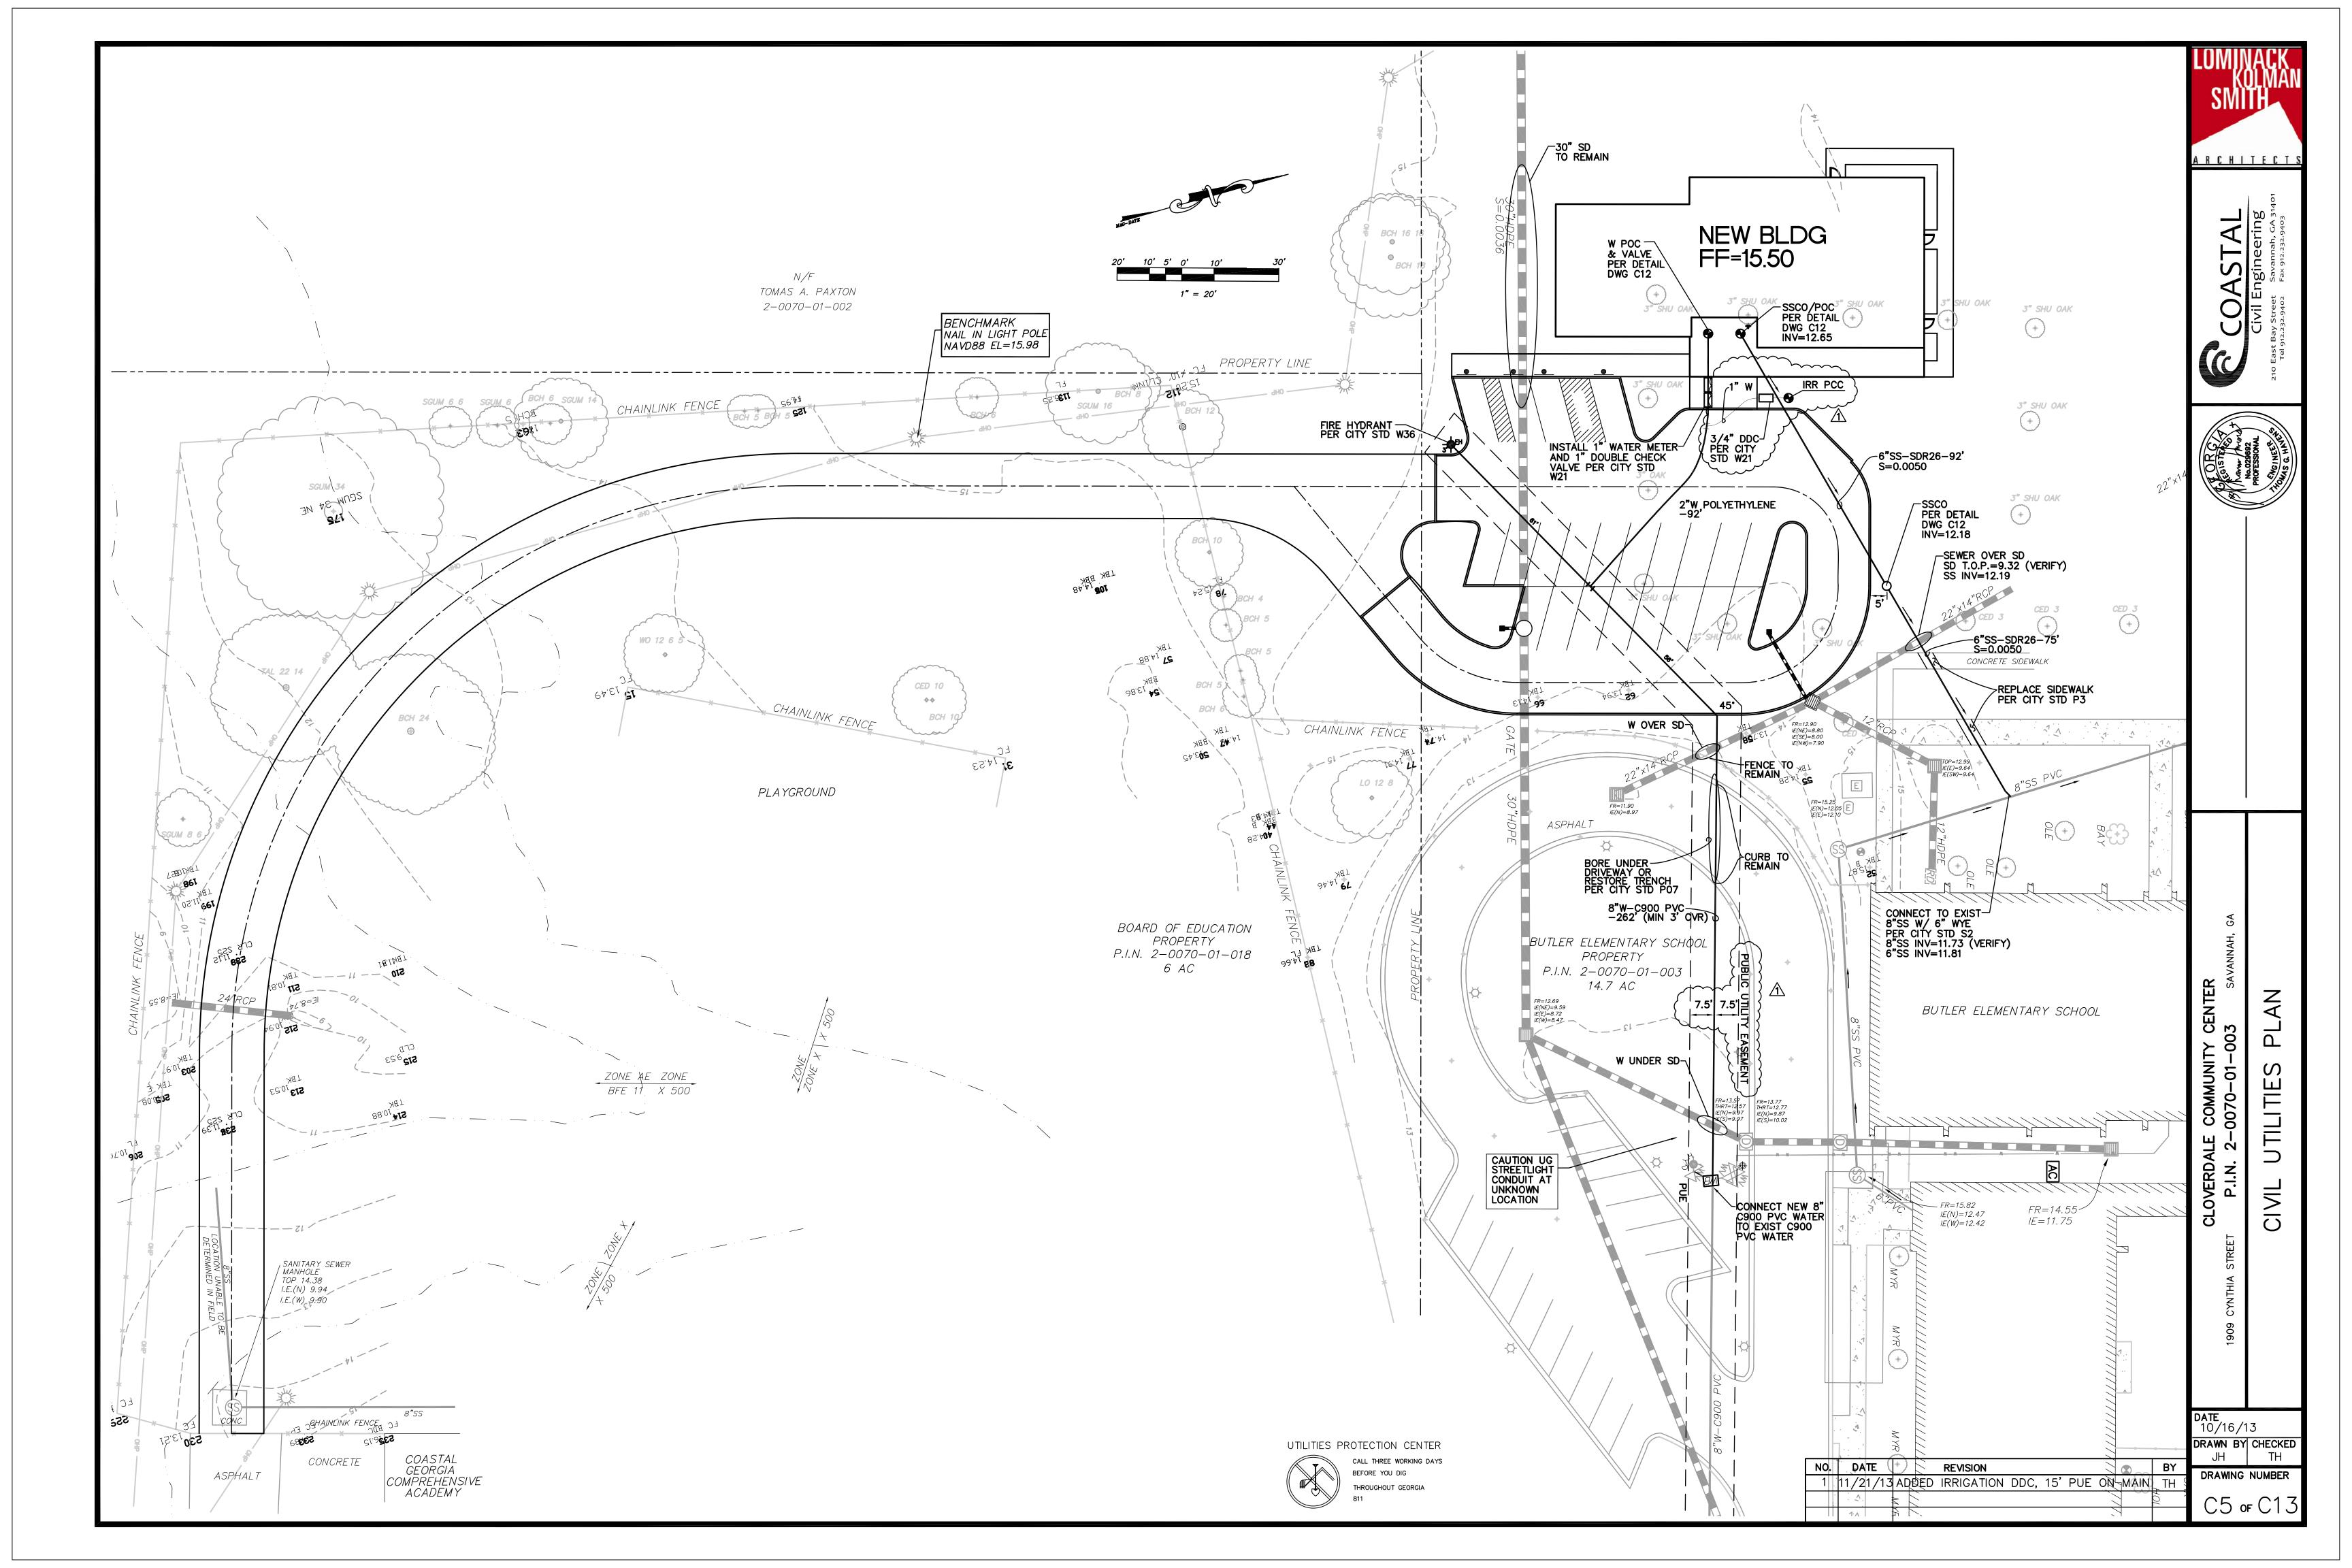

- Contractor shall install and maintain erosion control measures at all times. If full implementation of the approved plan does not provide for effective erosion control, additional sediment and erosion control measures shall be implemented to control or treat the sediment source.
- The escape of sediment from the site shall be prevented by the installation of erosion and
- sediment control measures and practices prior to, or concurrent with land disturbing activities. 3. All grassing shall be in accordance with the Georgia Department of Transportation Specifications, latest edition.
- 4. Temporary grass seed shall be per chart below. Permanent grass seed shall be selected by the owner.
- 5. Seed and fertilizer shall be either applied mechanically or by hydro—seeding. Hydro—seeding requires the application of fiber and stabilizing emulsion. Mechanical application shall require rolling, tamping, or otherwise working the seed and fertilizer into the soil.
- . Additionally, after seeding fill slopes, straw shall be applied at the rate specified below and incorporated into the soil. In lieu of straw, the Contractor may hydro—seed disturbed areas incorporating stabilizing emulsion.

ITEM SPREAD RATE (Pounds per acre) Per table below Grass Seed Fertilizer (16-20-0 &15% Sulfur) 4,000

Fiber (For Hydro Seeding)

2 x 4 Steel frame

Stabilizing emulsion (for hydro-seeding) shall be installed per manufacturer's recommendations. Emulsion shall be non-asphaitic, and derived from plants.

- 7. Construction activities shall be scheduled to minimize erosion.
- 8. Only disturb, clear, or grade areas necessary for construction.
- 9. Use grooving or tracking to roughen the face of slope to facilitate vegetation establishment. Apply seed, fertilizer and straw mulch and then track or punch in mulch with bulldozer on 3:1 or steeper
- 10. After any rainfall inspect any structure used to trap sediment and clean out or repair promptly. Inspect channels at regular intervals and after significant storms. Remove debris, if necessary and make needed repairs. Repair eroded areas promptly.
- . Soils on site are Type OjC (Ocilla-Urban Land Complex) soils, which are in hydrologic group C.
- 12. Silt fence/straw wattles shown on plans represent limits of disturbance.
- 13. Storm water leaving the existing site flows towards and existing 24" RCP strom drain culvert to the south and into a 30" HDPE that flows to a detention pond just west of the new building.
- 14. The first order of work shall be the erection of tree protection fencing.
- 15. Any disturbed area left exposed for a period greater than 14 days shall be stabilized with mulch or temporary seeding.
- 16. Any amendments or revisions to this ES&PC plan which have significant impact to hydraulics must be certified by the design professional
- 17. The project designer certifies that this ES&PC plan provides for a comprehensive system of BMP's and sampling to meet permit requirements as stated on pages 12-13 of permit.
- 18. The design professional who prepared the ES&PC plan is to inspect the installation of the initial sediment storage requirements and perimeter control BMPs within seven days after installation.
- 19. Waste materials shall not be discharged into waters of the State during the course of work on this project.
- 20. This ES&PC plan is in compliance with waste disposal and sanitary sewer regulations.

Wire-backing

FABRIC AND SUPPORTING

FRAME FOR INLET PROTECTION

21. Any petroleum spills or leaks that occur during the course of construction shall be isolated and removed immediately from the project site. Contaminated material shall be disposed of in a landfill approved for acceptance of the material.

with grate


Hard Surface Public Road


N.S.A. R-2 (1.5"-3.5"

Geotextile Underline

Coarse Aggregate

- 22. There are no State waters on or within 200' of the project site.
- 23. Stormwater run off from this site is eventually received by the Musgrave Canal. This canal discharges into the Springfield
- Canal, and then into the Savannah River. The contractor shall maintain appropriate dust control Du in accordance with local ordinances and requirements. Dust control
- shall be provided by irrigation, temporary mulching (Ds1), temporary seeding (Ds2) or spray on adhesives (Tb) 25. Concrete Truck Washing— NO concrete trucks will be allowed to wash out or discharge surplus concrete or drum wash water onsite.

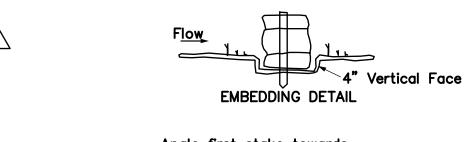

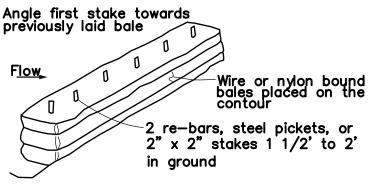

ANCHORING DETAIL

Anchor and embed into soil to prevent washout or water working under barrier Repair or replacement must be made promptly as needed

STAKED HAYBALE BARRIERS

CONTACT INFORMATION

DEVELOPER/OWNER GREGORI ANDERSON BUILDING SAFETY AND REGULATORY SERVICES 1117 EISENHOWER DRIVE SAVANNAH, GA 31406 TEL 912-201-4300

Buried fabric

CRUSHED STONE

CONSTRUCTION EXIT

24 HOUR EROSION CONTROL CONTACT GREGORI ANDERSON BUILDING SAFETY AND REGULATORY SERVICES 1117 EISENHOWER DRIVE SAVANNAH, GA 31406 TEL 912-201-4300

TOTAL PROPERTY AREA: 20.70 ac TOTAL DISTURBED AREA: 1.20 ac

The escape of sediment from the site shall be prevented by the installation of erosion and sediment control measures and practices prior to, or concurrent with, land disturbing activities

PROJECT DESCRIPTION

THIS PROJECT CONSISTS OF THE CONSTRUCTION OF A NEW BUILDING AND PARKING LOT LOCATED ADJACENT TO BUTLER ELEMENTARY SCHOOL IN THE CLOVERDALE NEIGHBORHOOD. THIS FACILITY WILL BE OPERATED AS A COMMUNITY CENTER.

REQUIRED INSPECTIONS

Daily Inspections Weekly or After	Weekly or After 0.5" Min Rainfall Event	Monthly
All areas where petroleum products are stored, used or handled for spills or leaks from vehicles	All areas that have not undergone final inspection	All areas that have undergone final stabilization
All locations where vehicles leave or enter the site	All materials storage areas exposed to precipitation that have not undergone final stabilization	
Rainfall for each 24—hour period	Structural control measures.	

Records of required inspections and sampling must be maintained in accordance with NPDES requirements.

REQUIRED SAMPLING

- 1. Turbidity sampling is required in accordance with NPDES Genral Permit GAR100001.
- 2. Two sampling events are required over the course of the project at the indicated locations on the plan:
 - a) First rainfall event greater than 0.5" after all clearing and grubbing operations are complete.
- b) First rainfall event greater than 0.5" after all mass grading operations have been completed.
- 3. Samples shall be analyzed for turbidity in accordance with Appendix B. Turbidity shall not exceed indicated values. Samples shall be collected in accordance with NPDES requirements. Based on a total construction site area between between 1 and 10 acres, and a total surface water drainage area of 0-4.99 square miles, the NTU value is 75.
- All analyzed samples shall be reported in accordance with NPDES requirements.

TEMPORARY SEEDING

	OLLD		
MONTH OF PLANTING	GRASS TYPE	RATE/ACRE ALONE	MIX
JANUARY	RYEGRASS	40 LBS.	10 LBS.
FEBRUARY	ANNUAL LESPEDEZA RYE	40 LBS. 168 LBS	10 LBS. 28 LBS
MARCH	WEEPING LOVEGRASS	4 LBS.	2 LBS.
APRIL-MAY	WEEPING LOVEGRASS SUDAN GRASS BROWN TOP MILLET	60 LBS. 40 LBS.	10 LBS.
JUNE, JULY AUGUST	SUDAN GRASS OR BROWN TOP MILLET	60 LBS. 40 LBS.	10 LBS.
SEPTEMBER	RYEGRASS OATS	128 LBS	16 LBS.
OCT, NOV DECEMBER	RYEGRASS, OATS RYE, WHEAT	180 LBS	16 LBS.

DRAINAGE DATA DISTURBED AREA= 1.20 ac FEMA FLOOD ZONE X PER FIRM MAP 13051C0153F DATED 9/26/08

IN CHATHAM COUNTY, GA

SITE

CLOVERDALE DR

CHEVY CHASE RD

I–16

VICINITY MAP

IMPERVIOUS AREA
PRE-PROJECT=0.00 ac
POST PROJECT=0.47 ac PERVIOUS AREA
PRE-PROJECT=1.20 ac
POST PROJECT=0.73 ac

PRE-DEVELORMENT RUNOFF 25 YEAR VOLUME=26,583 CF 25 YEAR PEAK=5.39 CFS

POST-DEVELOPMENT RUNOFF 25 YEAR VOLUME=30,557 CF 25 YEAR PEAK=6.05 CFS **DETENTION**

Storage Calculations

 Drainage area = 1.20 acres
 Required sediment storage = 67 cy/ac* drainage area Required sediment storage = 67 cy/ac* 1.20 ac = 80 cy Required sediment storage = 80cy = 2160 cf Provided with silt fence

- 1,760' long triangle=length of silt fence $V=[8'W \times 0.5'H \times 1,760'L].5=3,520$ cf

3,520 cf = 130 cy > 80 cy = okEROSION CONTROL MEASURES WILL BE MAINTAINED AT ALL TIMES. IF FULL IMPLEMENTATION OF


THE APPROVED PLAN DOES NOT PROVIDE FOR EFFECTIVE EROSION CONTROL, ADDITIONAL SEDIMENT AND EROSION CONTROL MEASURES SHALL BE IMPLEMENTED TO CONTROL OR TREAT THE SEDIMENT SOURCE

BEFORE YOU DIG

THROUGHOUT GEORGIA

ANY DISTURBED AREA LEFT EXPOSED FOR A PERIOD GREATER THAN 14 DAYS SHALL BE STABILIZED WITH MULCH OR TEMPORARY SEEDING.

SCHEDULE PROPOSED

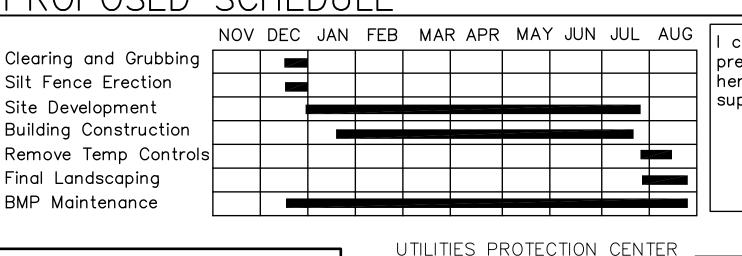

certify under penalty of law that this plan was prepared after a site visit to the locations described herein by myself or my authorized agent, under my supervision.

FOR ADDED PROTECTION

PROVIDE 4" DEEP WOOD CHIP MULCH OVER ANY UNPROTECTED ROOT ZONE. - MAKE CLEAN CUTS ON ROOTS EXPOSED BY GRADING AND BACKFILL IMMEDIATELY.

- PROVIDE TEMPORARY IRRIGATION WHERE PRACTICAL AND FEASIBLE.

CICH OF SAHANNAB

STANDARD CONSTRUCTION DETAILS

TREE PROTECTION

SIGNATURE ON FILE

/ Norman / Moures Momas G Havens, PE LÉVEL II CERTIFIED DESIGN PROFESSIONAL CERTIFICATION NUMBER 00000161162

-4' TEMPORARY CHAIN LINK FENCE

-GALVANIZED METAL POS

4' TEMPORARY CHAIN LINK FENCE

ROOT SYSTEM FROM MECHANICAL

LOCATED AT THE LIMITS OF THE

REE'S CRITICAL ROOT ZONE (A RADIUS

OF ONE FOOT PER INCH OF THE TREE'S

O PREVENT COMPACTION AND PUDDLING

OATED: JUNE 2005

DIAMETER AT BREAST HEIGHT) SO AS

OF THE SOIL OVER THE ROOT SYSTEM.

TRUCKS, BULLDOZERS, OR OTHER HEAVY EQUIPMENT SHOULD BE KEPT


AS FAR AWAY FROM THE TREE TRUNKS AND ROOTS AS POSSIBLE

REVISION

NO. DATE 1 | 11/21/13 ADDED DRAINAGE DATA 1 11/21/13 NOTATION REVISION

RCHITECT



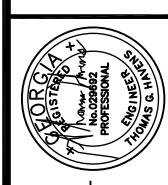

AIL

7

10/16/13 DRAWN BY CHECKED


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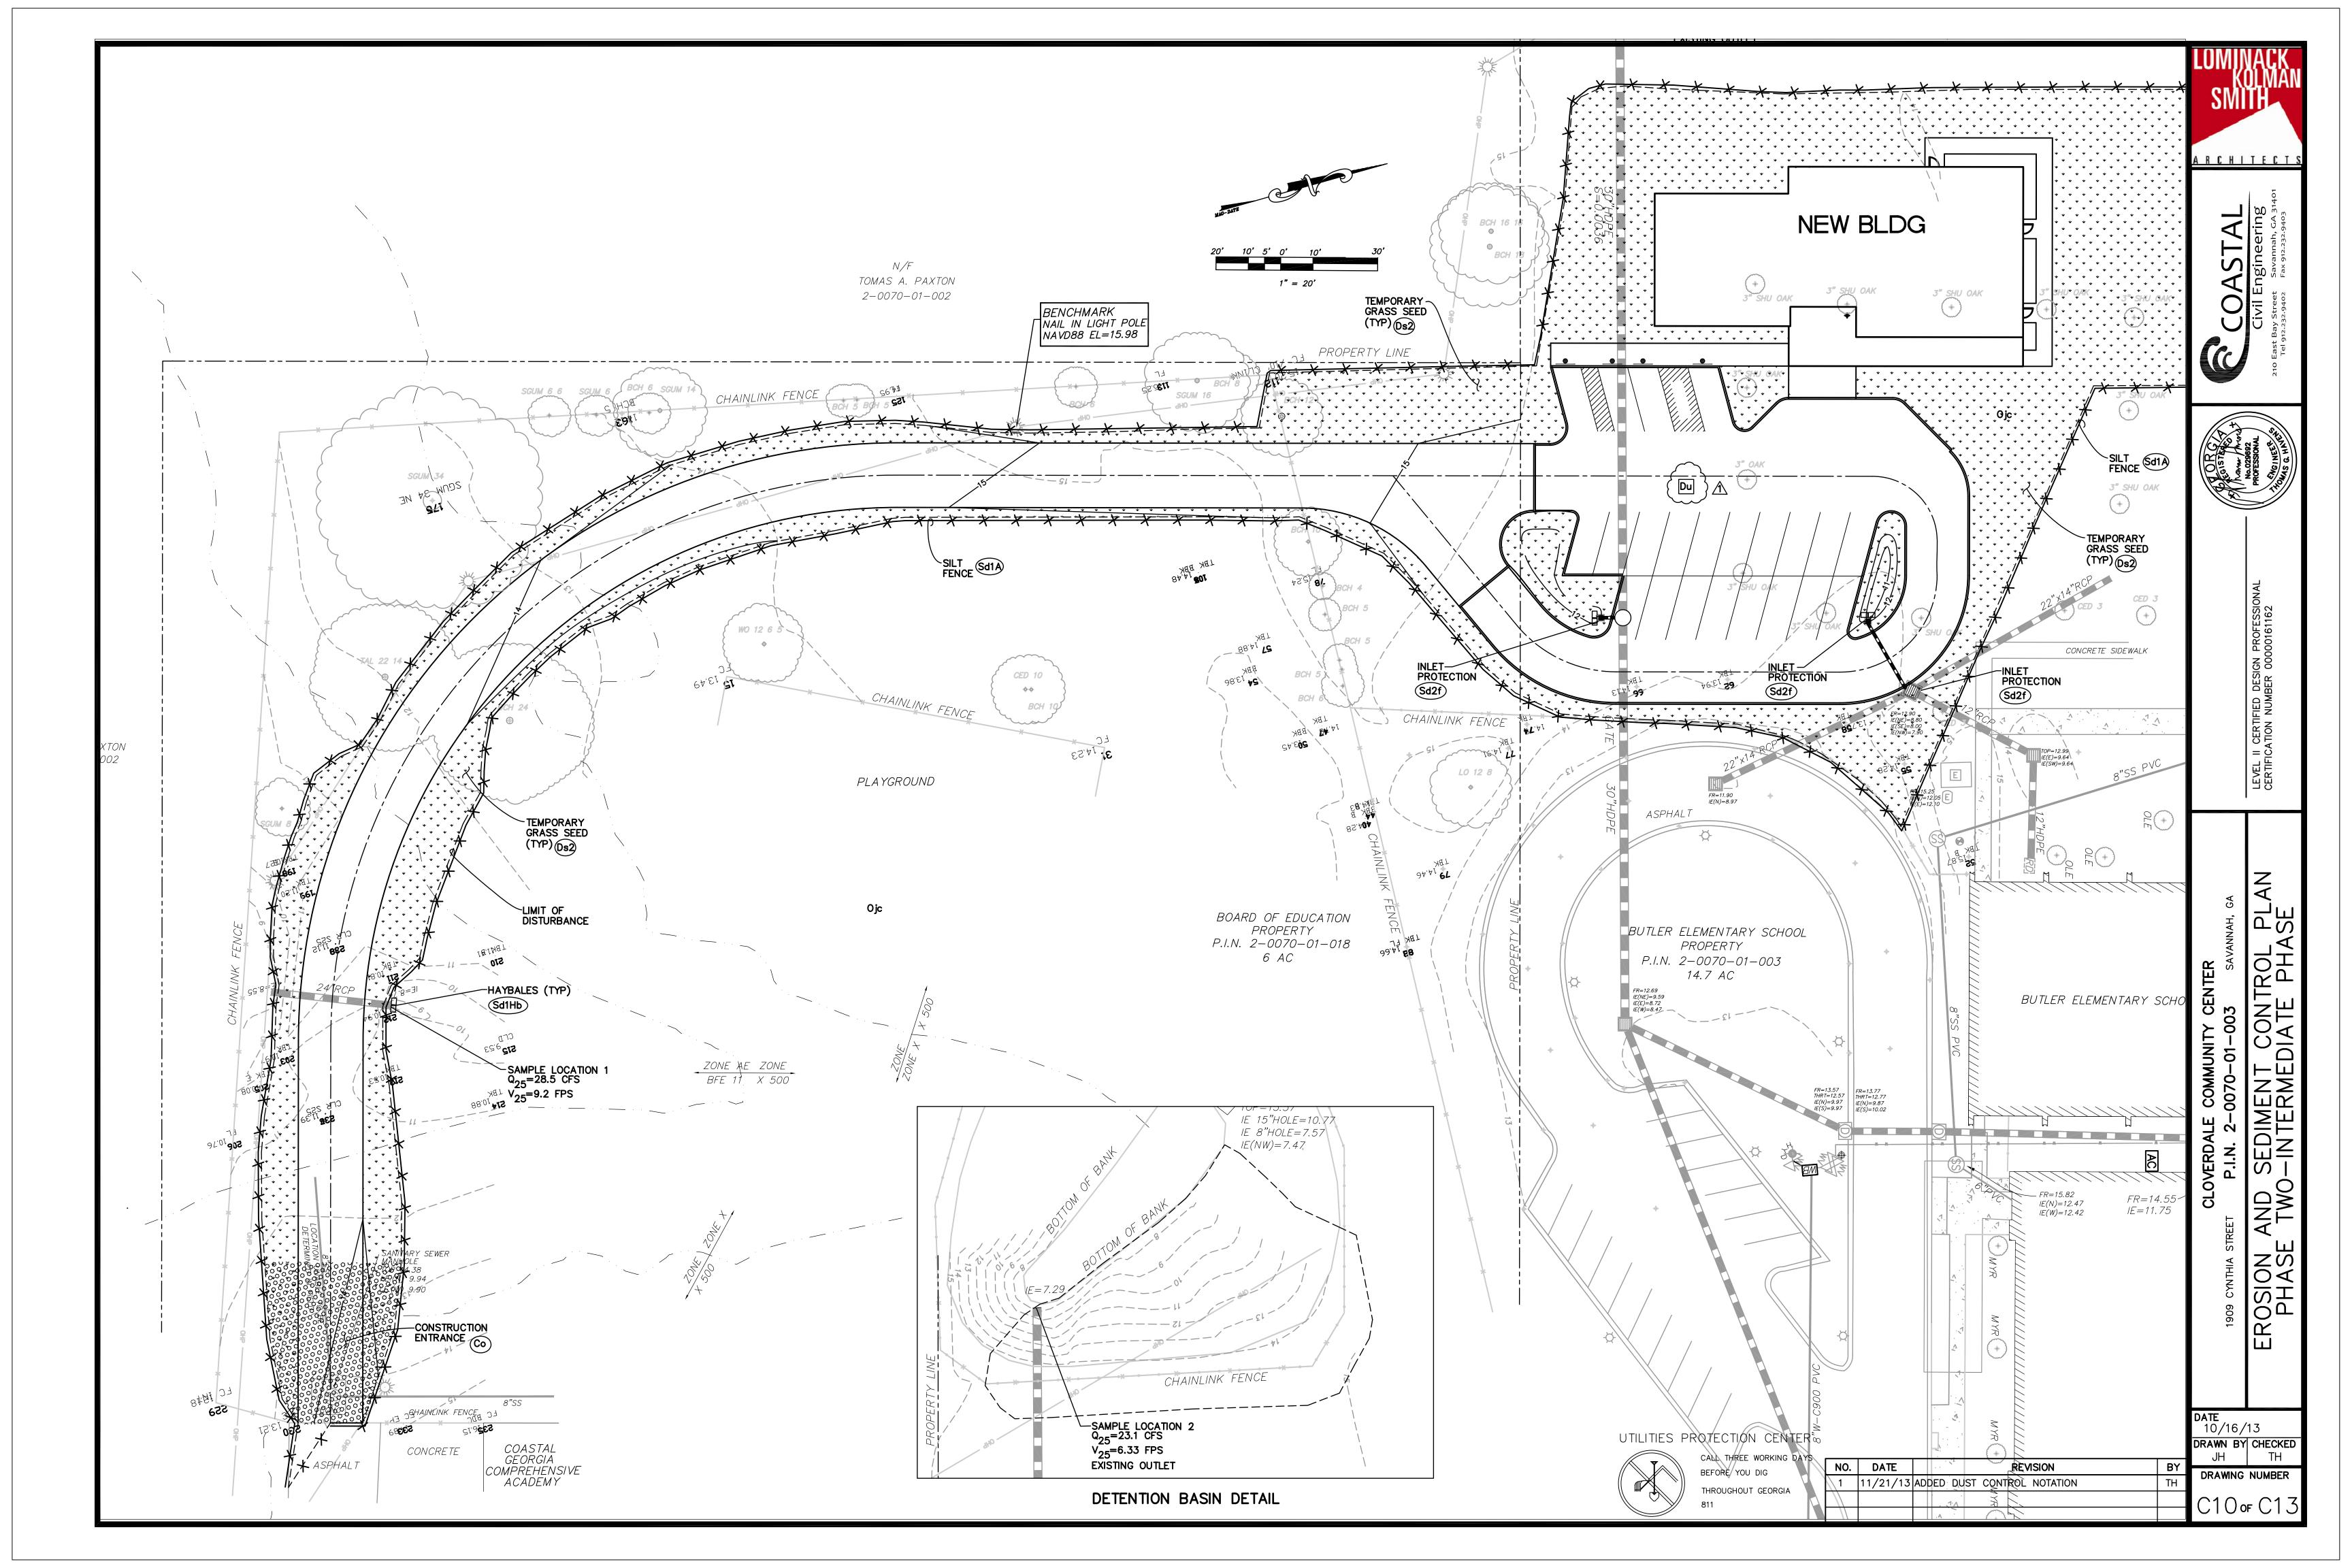
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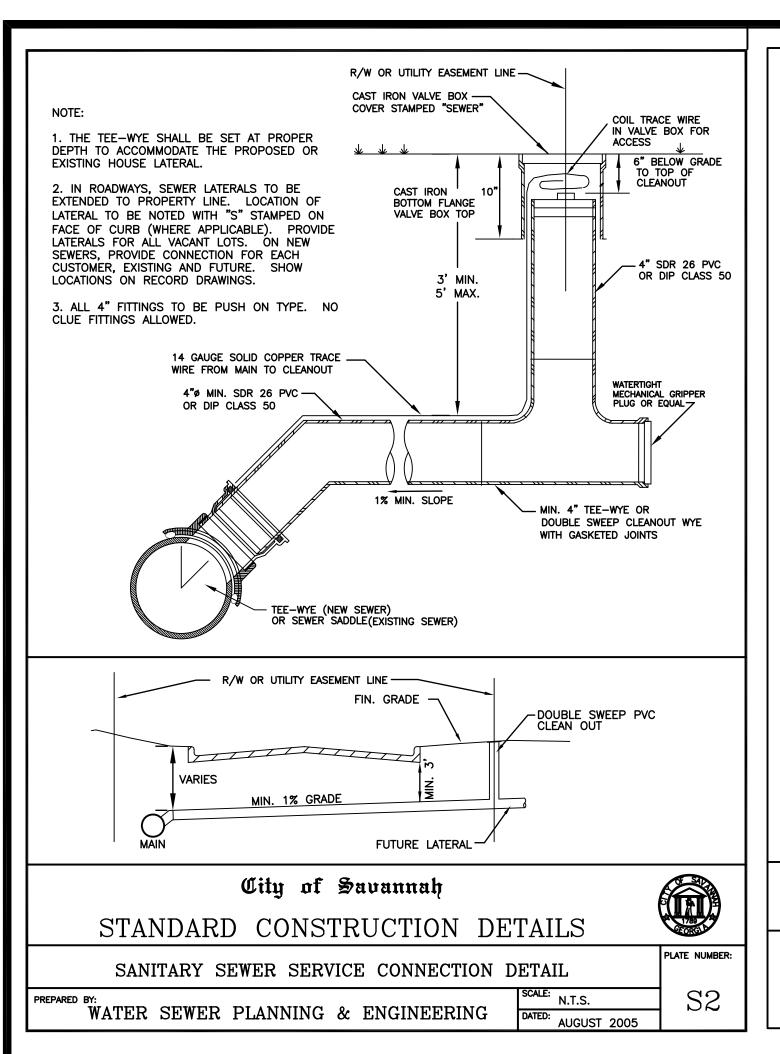
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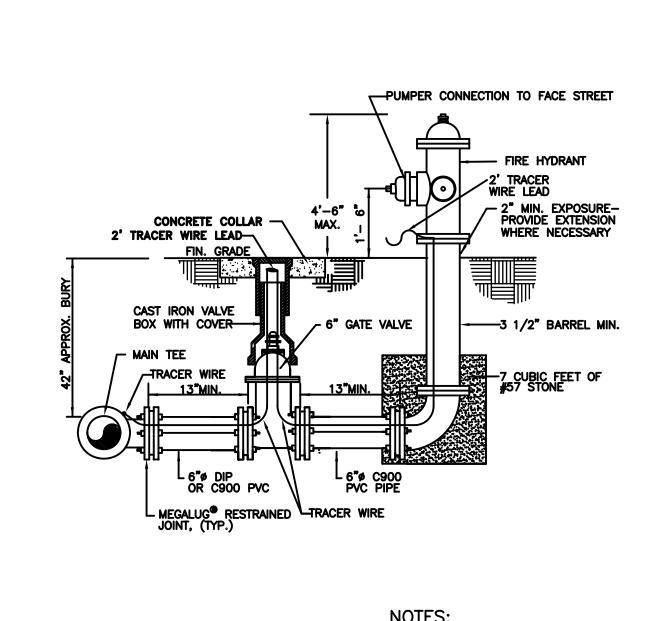
EROSION CONTROL DETAILS

SILT FENCE (TYPE A) Sd1A







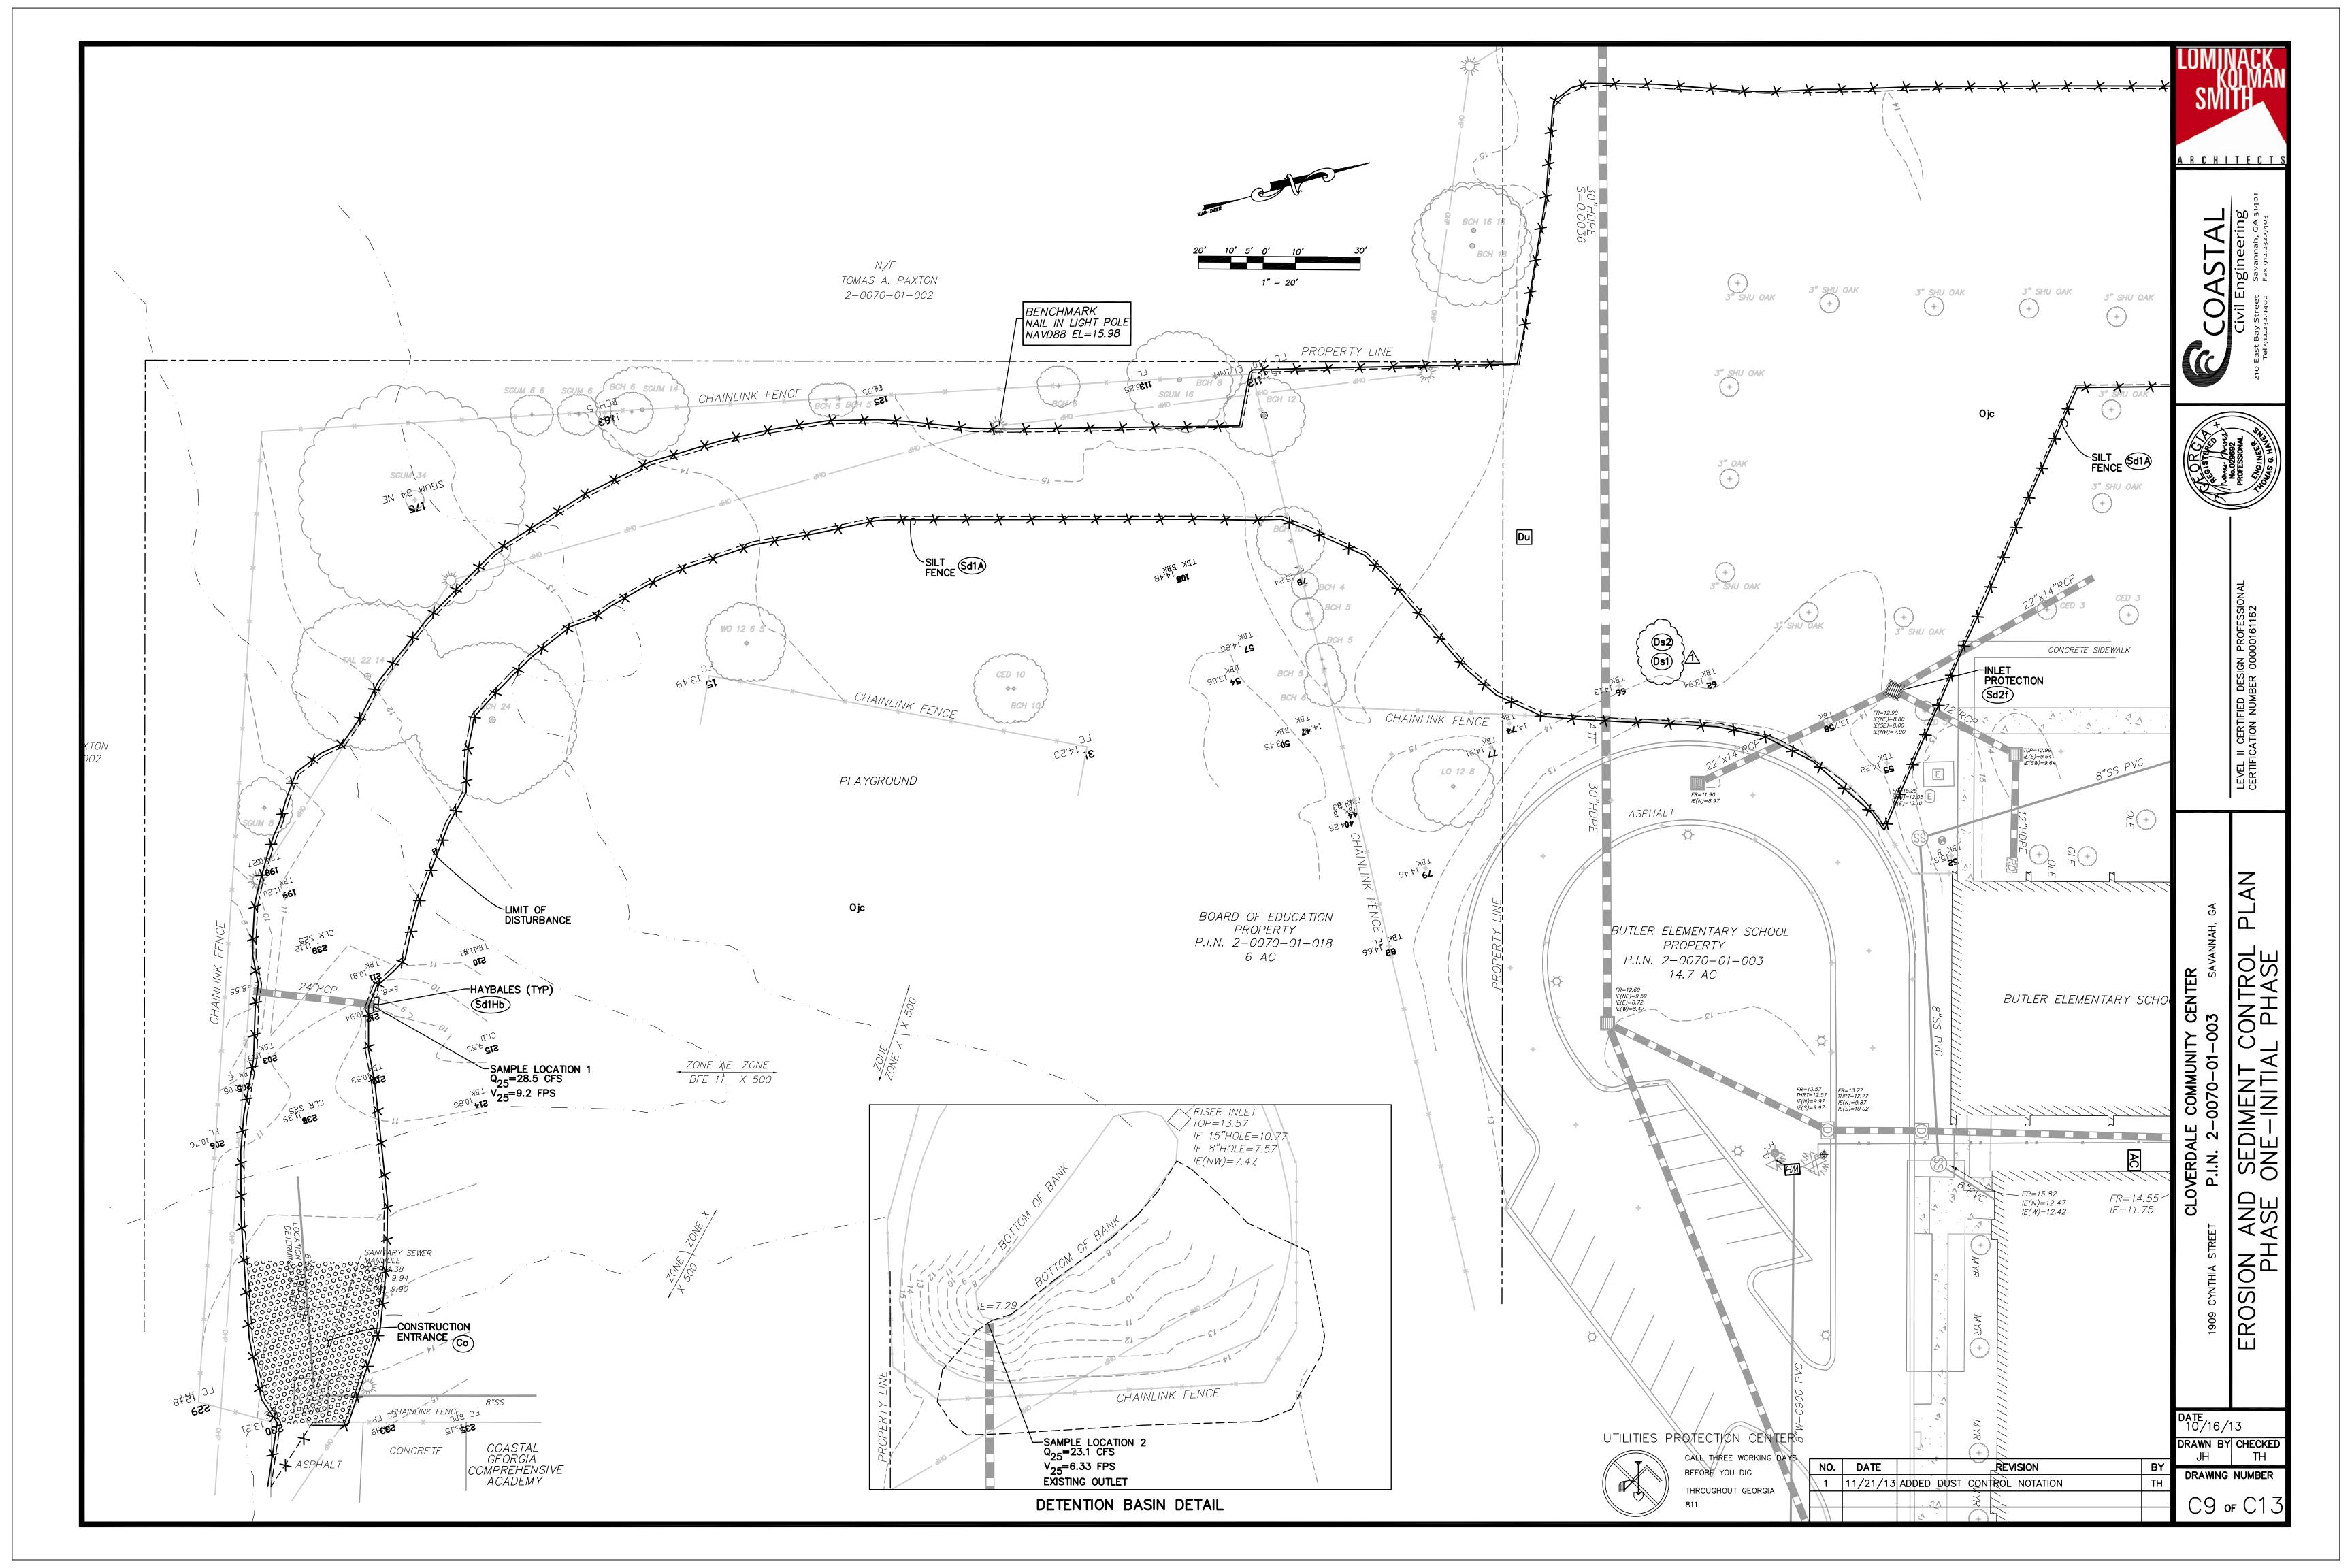

FIRE HYDRANT FOR STANDARD BURY MAINS

STANDARD CONSTRUCTION **DETAILS**



1.ALL JOINTS FROM MAIN TO

3. IN UNPAVED AREAS SET

FROM CONCRETE.

HYDRANT SHALL BE RESTRAINED.

2.PROTECT BOLTS AND THREADS

CONCRETE COLLAR 1" ABOVE THE

FINISHED GROUND. IN PAVED AREAS SET THE CONCRETE COLLAR FLUSH WITH THE EXISTING PAVEMENT.

> SCALE: N.T.S. DATED: SEP 2013 PLATE NUMBER: W36



SANITARY SERVICE LATERAL

SEE SANITARY SERVICE LATERAL

CONTRACTOR SHALL NOTIFY CITY OF SAVANNAH WASTEWATER CONVEYANCE

DEPARTMENT (912-351-3834) 24 HOURS

EXISTING GRAVITY SEWER PIPE MUST BE

PRIOR TO CONNECTION TO EXISTING GRAVITY SEWER PIPE. ALL CONNECTIONS TO THE

INSPECTED BY THE CONVEYANCE DEPARTMENT PRIOR TO BACK FILLING.

- PROPERTY LINE

SCALE: N.T.S.

DATED: SEP 2013

S3

PLATE NUMBER:

SCALE: N.T.S.

PLATE NUMBER:

DATED: SEP 2013

W1

CLEAN OUT DETAIL S2

MIN. 4"Ø PVC/DIP PIPE-

PVC INSERTA TEE™ OR FLEXIBLE-SEWER SADDLE WITH DOUBLE STAINLESS STEEL CLAMPS

EXISTING GRAVITY SEWER PIPE

MISCELLANEOUS NOTES

· CONSTRUCTION CONTRACTOR AGREES THAT IN ACCORDANCE WITH GENERALLY ACCEPTED CONSTRUCTION PRACTICES, GENERAL CONTRACTOR WILL BE REQUIRED TO ASSUME SOLE AND COMPLETE RESPONSIBILITY FOR JOB SITE CONDITIONS DURING THE COURSE OF CONSTRUCTION OF THE PROJECT, INCLUDING SAFETY OF ALL PERSONS AND PROPERTY: THAT THIS REQUIREMENT SHALL BE MADE TO APPLY CONTINUOUSLY AND NOT BE LIMITED TO NORMAL WORKING HOURS. AND CONSTRUCTION CONTRACTOR FURTHER AGREES TO HOLD HARMLESS, INDEMNIFY AND DEFEND THE OWNER, THE ARCHITECT AND HIS CONSULTANTS, AND EACH OF THEIR OFFICERS, EMPLOYEES, AND AGENTS.

. THE CONTRACTOR SHALL INDEPENDENTLY REVIEW GROUND, TOPOGRAPHY, AND TREE CONDITIONS THROUGHOUT THE SITE, AND ASSUME WHOLLY AND UNCONDITIONALLY THE RISK OF COMPLETING THE WORK SET OUT IN THESE PLANS, REGARDLESS OF ROCK, WATER TABLE, OR OTHER CONDITIONS WHICH THE CONTRACTOR MAY ENCOUNTER IN THE COURSE OF THE WORK.

3. ANY DISCREPANCY DISCOVERED BY THE CONTRACTOR IN THESE PLANS OR ANY FIELD CONDITIONS DISCOVERED BY THE CONTRACTOR THAT MAY DELAY OR OBSTRUCT THE PROPER COMPLETION OF THE WORK PER THESE PLANS SHALL BE BROUGHT TO THE ATTENTION OF THE ENGINEER AND THE OWNER IMMEDIATELY UPON DISCOVERY. SAID NOTIFICATION SHALL BE IN WRITING.

I. NO GUARANTEE IS INTENDED THAT UNDERGROUND UTILITIES OR OBSTRUCTIONS NOT SHOWN ON THESE PLANS MAY NO BE ENCOUNTERED. THOSE SHOWN ARE BASED ON THE BEST INFORMATION AVAILABLE AND THE CONTRACTOR IS CAUTIONED THAT THE OWNERS, THE ENGINEERS, AND THE ARCHITECT ASSUME NO RESPONSIBILITY FOR ANY EXISTING UTILITIES OR OBSTRUCTIONS, EITHER SHOWN OR NOT ON THESE PLANS.

. THE CONTRACTOR SHALL NOT BEGIN EXCAVATION UNTIL ALL EXISTING UTILITIES HAVE BEEN MARKED IN THE FIELD. THE CONTRACTOR SHALL NOTIFY THE UTILITIES PROTECTION CENTER AT LEAST THREE WORKING DAYS PRIOR TO EXCAVATION (800) 282-7411.

S. ALL GRADING SHALL BE IN CONFORMANCE WITH APPLICABLE PROVISIONS OF THE UBC AND THE PROJECT SOILS REPORT. THE CONTRACTOR SHALL BE RESPONSIBLE FOR COORDINATING WORK WITH THE SOILS ENGINEER.

ALL UNUSABLE MATERIAL, STUMPS, BOULDERS, REMOVED PAVEMENT AND UTILITIES, AND EXCESS SOIL SHALL BE REMOVED AND DISPOSED OF OFF THE PROJECT SITE AT THE CONTRACTORS EXPENSE.

8. NO JETTING OR FLOODING OF BACKFILL SHALL BE PERMITTED.

9. THE CONTRACTOR SHALL BE RESPONSIBLE FOR CLEANING PAVED ROADS OF DIRT, MUD, AND DEBRIS CAUSED BY HIS CONSTRUCTION OPERATIONS. MUD, DIRT AND DEBRIS SHALL BE REMOVED DAILY. SHOULD THESE ITEMS CONSTITUTE A PUBLIC HAZARD OR NUISANCE, THEY SHALL BE REMOVED IMMEDIATELY. THE CONTRACTOR SHALL PROMPTLY CLEAN STREETS WHEN REQUESTED BY THE DESIGNATED REPRESENTATIVE OF THE CITY OF SAVANNAH.

10.GRADING EQUIPMENT SHALL BE ADEQUATELY MUFFLED TO REDUCE THE NOISE IMPACT ON ADJACENT PROPERTIES. EQUIPMENT SHALL NOT OPERATE ON THE SITE PRIOR TO 8 A.M.

OR AFTER 5 P.M ON WEEKDAYS, AND SHALL NOT BE OPERATED ON WEEKENDS OR HOLIDAYS. 11.ANY MATERIALS, WORKMANSHIP, AND CONSTRUCTION SHALL CONFORM TO THE CITY OF SAVANNAH TECHNICAL

SPECIFICATIONS AND STANDARD CONSTRUCTION DETAILS. ${f \cancel{1}}$ 2.ALL WORK AND EQUIPMENT SHALL COMPLY WITH OSHA REQUIREMENTS.

\u033.THE CONTRACTOR SHALL OBTAIN AN ENCROACHMENT PERMIT PRIOR TO BEGINNING ANY WORK IN ANY ROADWAY, RIGHT-OF-WAY, ETC. FROM THE CITY OF SAVANNAH.

4. CHLORINATED DISINFECTED WATER SHALL NOT BE DISCHARGED INTO THE STORMWATER SYSTEM OR DITCH BORDERING THE PROJECT.


15.ALL TRENCH BEDDING AND BACKFILL SHALL BE PER CITY STD S26.

(16. DUST CONTROL MEASURES SHALL BE INSTITUTED DURING GRADING ACTIVITIES TO PREVENT A DUST NUISANCE TO ADJACENT PUBLIC AND PRIVATE PROPERTIES.

17.6GRADING EQUIPMENT SHALL BE ADEQUATELY MUFFLED TO REDUCE THE NOISE IMPACT ON ADJACENT PROPERTIES. EQUIPMENT SHALL NOT OPERATE ON THE SITE PRIOR TO 8 A.M. OR AFTER 5 P.M ON WEEKDAYS, AND SHALL NOT BE OPERATED ON WEEKENDS OR HOLIDAYS.


 $^{\prime}$ 18.SEE LANDSCAPE AND ARCHITECTURE DRAWINGS FOR ADDITIONAL DETAILS.

19. THE CONTRACTOR SHALL POTHOLE AND VERIFY THE DEPTH OF EXISTING STORM DRAIN AND SEWER FACILITIES PRIOR TO EXCAVATING TRENCHES OR ORDERING STRUCTURES.

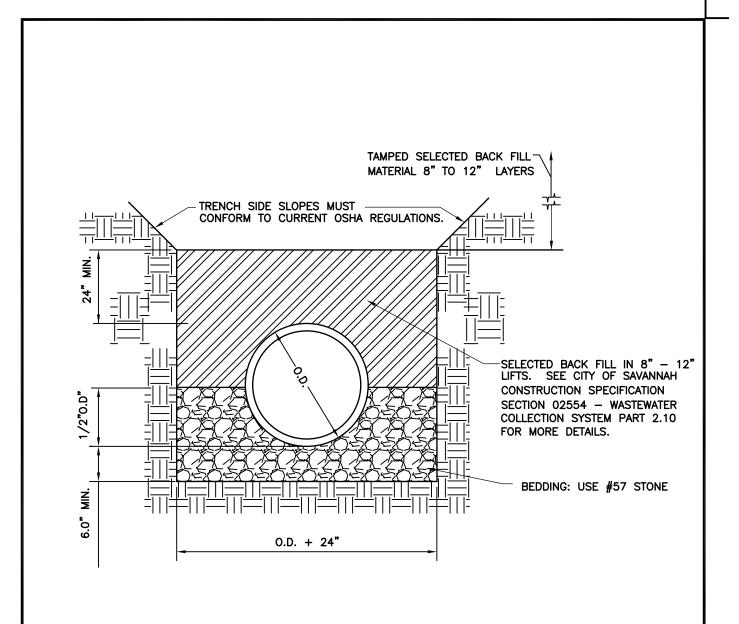

City of Savannah

STANDARD CONSTRUCTION DETAILS PLATE NUMBER: STANDARD PIPE BEDDING DETAIL S26 WATER & SEWER PLANNING & ENGINEERING DATED: AUG 2005

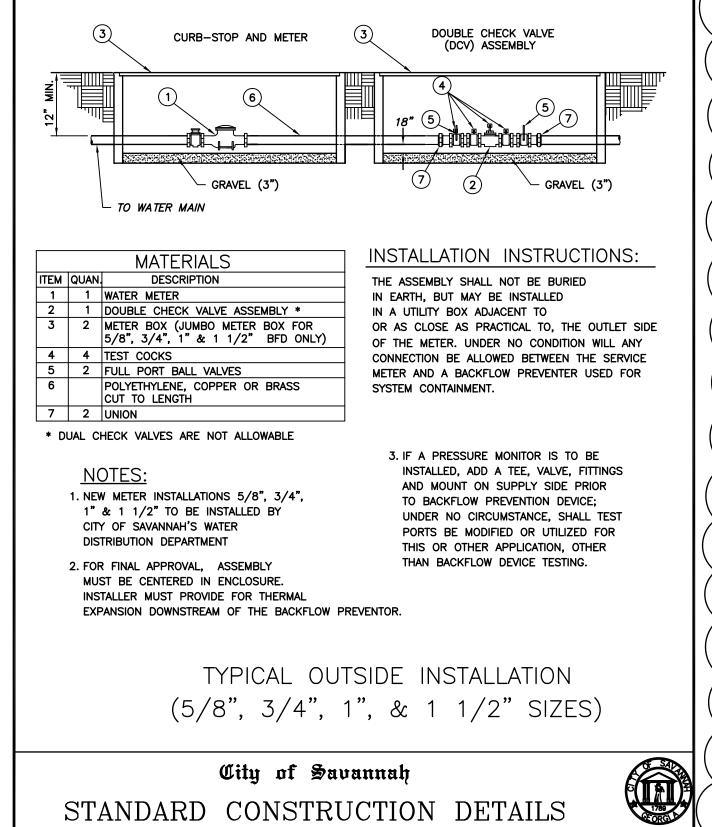



STANDARD CONSTRUCTION DETAILS

DOUBLE CHECK VALVE & METER ASSEMBLY

FOR DOMESTIC SERVICE FOR COMMERCIAL SITES

WATER & SEWER PLANNING & ENGINEERING

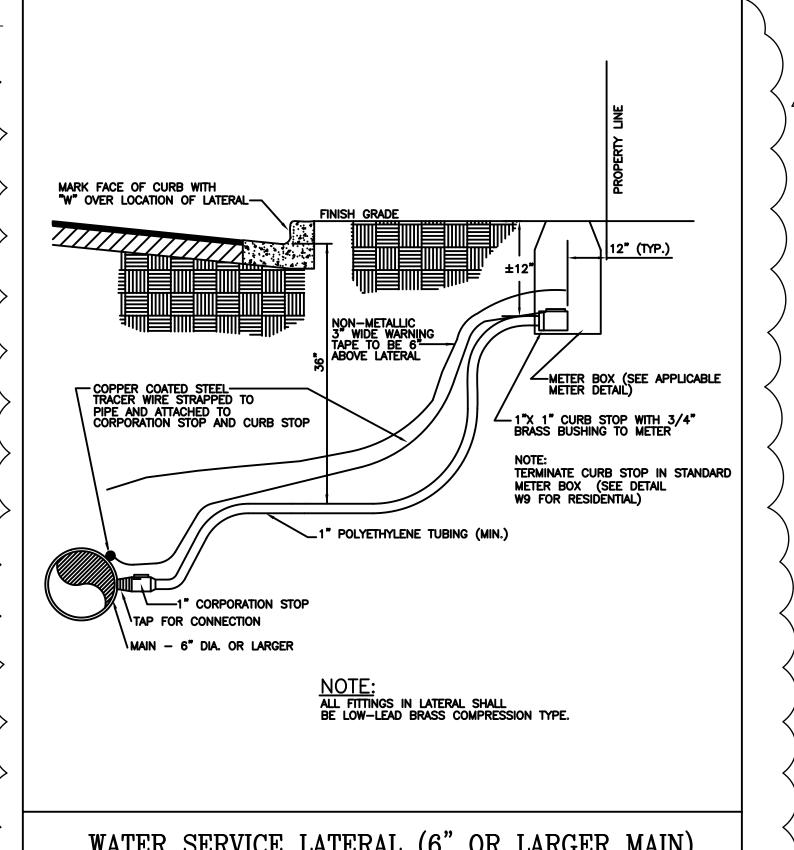

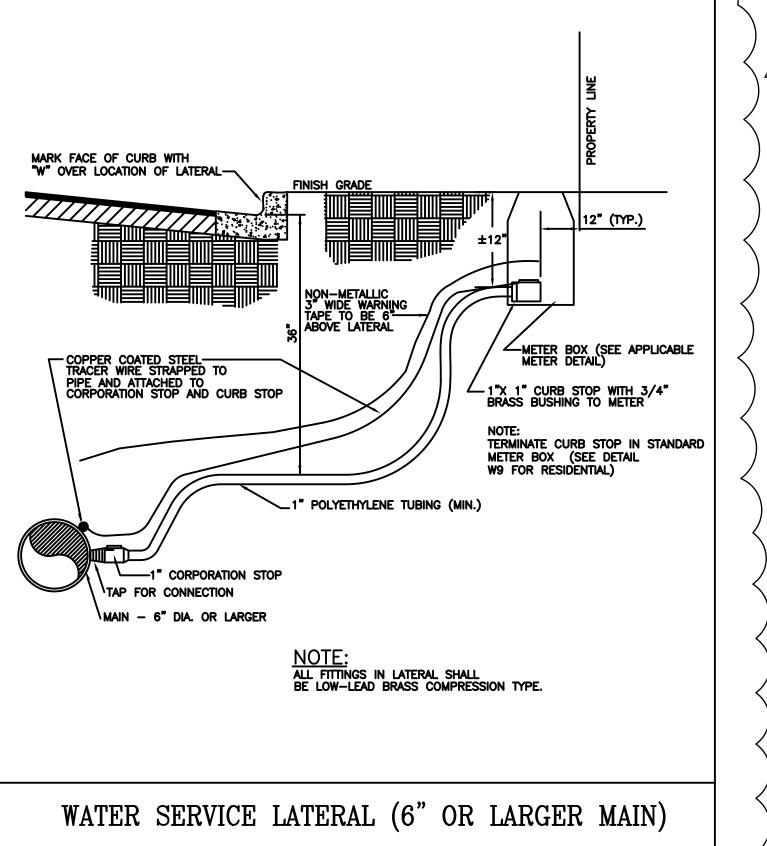

STANDARD CONSTRUCTION **DETAILS**

PLATE NUMBER:

W21

N.T.S.

MARCH, 2005



NO.	DATE	REVISION	E
1	11/21/13	REVISED CITY STD DETAILS	T


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TAIL ANEOUS MISCELL/

10/16/13 DRAWN BY CHECKED

DRAWING NUMBER C12 of C13



REQUIRED TREE QUALITY POINTS IS 1.2 AC(1600) TQP REQUIRED= 1920

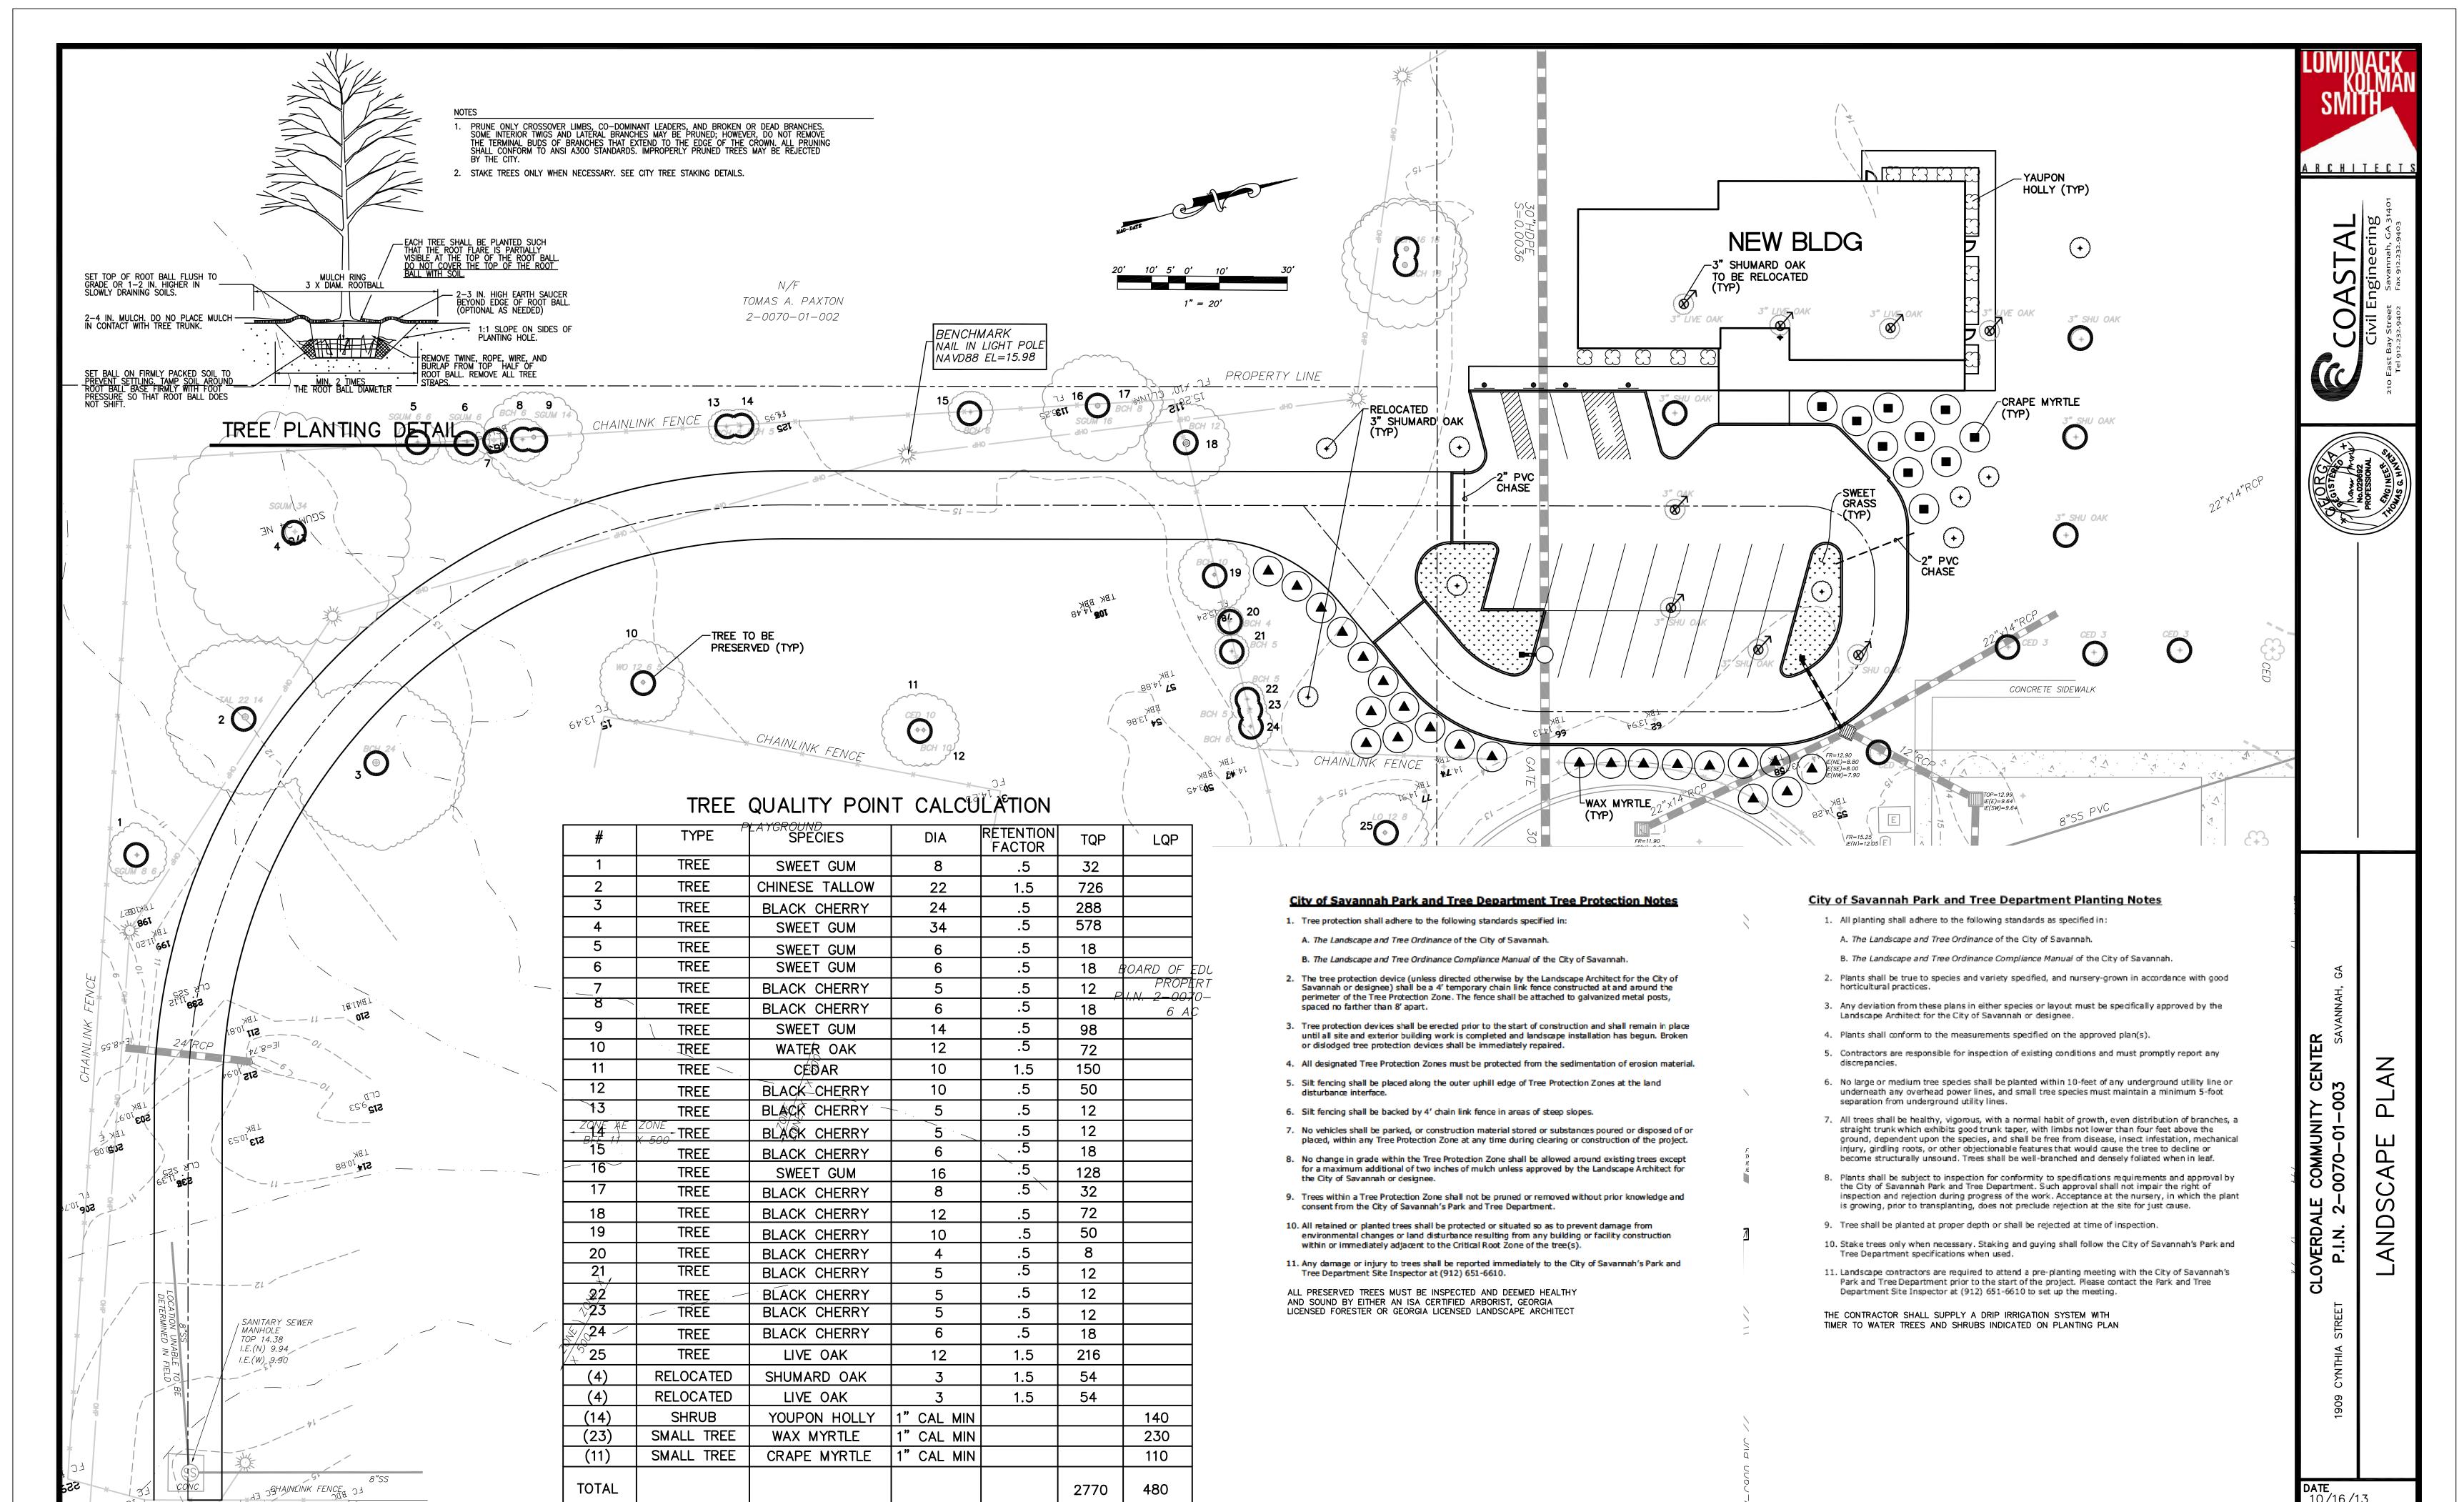PROVIDED PARKING QUALITY POINTS (6) SHUMARD OAKS=6(90)=540

REQUIRED LANDSCAPE QUALITY POINTS IS 1.2 ACRE(400) LQP REQUIRED= 480

REQUIRED PARKING QUALITY POINTS IS 0.3(1200) PARKING POINTS REQUIRED= 413

CONCRETE

ASPHALT

GEORGIA

COMPREHENSIVE

ACADEMY

DRAWN BY CHECKED
JH TH
DRAWING NUMBER

DATE

REVISION

LT OF LT