LEGEND & ABBREVIATIONS DESCRIPTION ABBREVIATION SYMBOL HOT WATER SUPPLY - HWS -HOT WATER RETURN HWR METERED BALANCING VALVE MBV - \triangleright \forall GATE VALVE GV. CHECK VALVE CV --- CHS ---CHILLED WATER SUPPLY CHS ----- CHR ---CHILLED WATER RETURN CHR ---|∞---MOTOR OPERATED (2-WAY) VALVE MOV STRAINER UNION FIRE DAMPER FD ◆ OR -----SINGLE LINE DUCT FLEXIBLE DUCT + DUCT TRANSITION ____ ROUND PIPE UP PIPE OR DUCT DOWN -----DIRECTION OF FLOW MANUAL DAMPER MLD/MD (T) THERMOSTAT T'STAT MOTOR OPERATED DAMPER MOD **---**-[M] DUCT MOUNTED SMOKE DETECTOR SKD ◆ OR □ SMOKE DETECTOR SMD TEMPERATURE SENSOR CONDENSER WATER SUPPLY CS CONDENSER WATER RETURN : CR ----CR

FANS - SUPPLY OR EXHAUST

EF-1

9120

1.25

5

BELT

ROOF

SYMBOL

MAX. SONES

EXT. STATIC PRESS., IN.H2O

MAX. FAN SPEED, RPM

MAX. TIP SPEED, FPM

MAX. OUTLET VELOCITY. FPM

MAX. MOTOR HP

ELECTRICAL CHARACTERISTICS

DRIVE

LOCATION

REMARKS

TYPE

EF-5

425

0.5

9.0

1/4

BELT

SECOND FLR

SF-2

С

12,980

0.375

18.8

3

BELT

BASEMENT

SEE ELECT. DWG | SEE ELECT. DWG | SEE ELECT. DWG | SEE ELECT. DWG | SEE ELECT. DWG

SF-3

7820

0.375

14.4

1-1/2

BELT

ROOF

and the second s

ABBREVIATION	DESCRIPTION
AFF	ABOVE FINISHED FLOOR
A/C	ABOVE CEILING
AHU	AIR HANDLING UNIT
AD	DUCT ACCESS DOOR
BTUH	BRITISH THERMAL UNITS PER HOUR
CFM	CUBIC FEET PER MINUTE
CLG	CEILING
DN	DOWN
DWGS	DRAWINGS
EA	EXHAUST AIR DUCT (EXISTING)
EF	EXHAUST FAN
ELEC	ELECTRIC
EXH	EXHAUST
EXIST	EXISTING
GPM	GALLONS PER MINUTE
HVAC	HEATING VENTILATING & AIR CONDITIONIN
MAX	MAXIMUM
MIN	MINIMUM
TG	TRANSFER GRILLE
TYP ,	TYPICAL
VAV	VARIABLE AIR VOLUME UNIT
CTE	CONNECT TO EXISTING
RA	RETURN AIR
OA	OUTSIDE AIR
SA	SUPPLY AIR
LVG	LEAVING
ENT	ENTERING
TEMP	TEMPERATURE
PRESS	PRESSURE
SF	SUPPLY FAN
DP	DIFFERENTIAL PRESSURE
EMS	ENERGY MANAGEMENT SYSTEM
СТ	COOLING TOWER
CH	CHILLER
CHP	CHILLED WATER PUMP
CWP	CONDENSER WATER PUMP
HWP	HOT WATER PUMP

EF-6

С

1025

0.5

7.5

?. ___

1/4

BELT

FOURTH FLR

EF-7

С

400

0.5

9.0

1/4

BELT

FIFTH FL

		DESIGN C	ONDIT	10 N	15			
DESCRIPTION			-	INSIDE			OUTSID	
FINISHED FLOOR	UNIT	AREA	HEAT.	. 000	ING	HEAT.	C00	LING
CEILING			DB F	DB F	WB F	DB F	DB F	WB F
ANDLING UNIT	ALL	ALL	72	75	62	24	95	79
ACCESS DOOR SH THERMAL UNITS PER HOUR								
FEET PER MINUTE								<u> </u>
NG			· · · · · · · · · · · · · · · · · · ·	-				
NGS ST AIR DUCT (EXISTING)	GENERAL NOTES:							
ST FAN	1. COORDINATE ALL W	ORK WITH OTHER TR	ADES PRIO	R TO I	NSTALL	ATION.		

2. UNLESS OTHERWISE INDICATED, INSTALL ALL SPACE THERMOSTATS, HUMIDISTATS AND SENSORS 54 INCHES ABOVE FINISHED FLOOR.

3. DUCT SIZES SHOWN ARE ACTUAL INSIDE DIMENSIONS.

AIR HANDLING UNITS

SYMBOL

TYPE

- 4. FLEXIBLE OR ROUND DUCT SHALL BE CONNECTED TO RECTANGULAR OR SQUARE DUCT WITH A SPIN-IN COLLAR WITH SCOOP AND DAMPER.
- 5. INSTALL TURNING VANES IN ALL 45 AND 90 DEGREE MITERED ELBOWS.

AHU-1


EXISTING


6. ALL WORK SHALL BE DONE AFTER HOURS. ALL SHUT DOWNS TO BE COORDINATED WITH USER. ALL MATERIAL REMOVED SHALL BE TAKEN FROM BUILDING AND PROPERLY DISPOSED OF EACH DAY. NO TRASH OR OTHER MATERIALS REMOVED SHALL REMAIN IN AREA UNLESS MATERIAL IS TO BE

AHU-2

EXISTING

AIR DI	STRIBL	JTION DE	VICES	
SYMBOL 1	LOCATION	FUNCTION	TYPE	SURFACE TYPE
A	CEIĽING	SUPPLY	PERFORATED REGISTER	LAY-IN
В	CEILING	RETURN	PERFORATED REGISTER	LAY-IN
(C)	CEILING	EXHAUST	LOUVERED FACE	SURFACE MNT
D	CEILING	SUPPLY	LOUVERED FACE	SURFACE MNT
(x)	CEILING	EXISTING	EXISTING	EXISTING

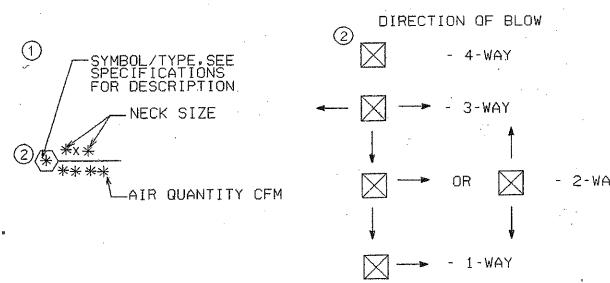

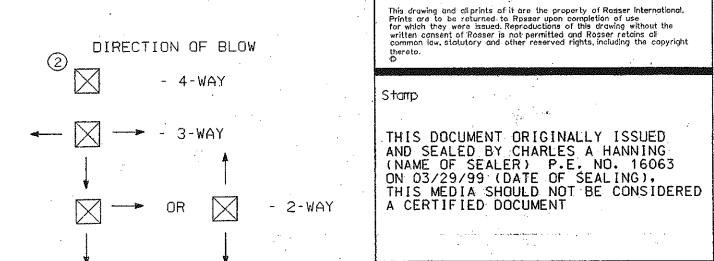

<i>'</i> .	No.	<u>Date</u>	<u>DescrIption</u>
	<u> </u>	12/13/99	GENERAL REVISION
,	<u> </u>	03/08/00	GENERAL REVISION
	<u>A</u>	12/20/00	COMPUTER ROOM UNITS
•	<u>A</u>	03/13/01	COIL CHANGE
,		-	
*		· · ·	
			•
		•	

Rosser International, Inc.

Atlanta, Savannah, Houston, Los Angeles

Architects and Engineers

128 West Bay St.

Savannah, Ga. 31402 (912) 232 1146

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Key Plan

SCHEDULES

M0.1

Job NO. 98132 Drawn ____SMC_ Checked CAH

Date 26-JUL-2001 Sheet No.

TO	TAL CFM	42,000	36.400	43,000	41.000				
ΜI	NIMUM CFM	23,295	0	19.505	19,890				
MI A I	NIMUM OUTSIDE R, CFM	12,980	0	7820	10,580	\triangle			
EX PR	T. STATIC ESSURE . IN. H2O	4.0	4.0	5.0	S-6.0/R-1.0	5			•
ΔM	X. FAN MOTOR HP	75	50		S-75/R-20	5			
	CAPACITY, BTU/HR	2,100,000		1,615,900	1,740,700				
	ENT. AIR DB, °F	80.6		78:3	80.1			• .	3
016	ENT. AIR WB, °F	68.0		65.9	. 67.6				
O	LVG. AIR DB, °F	53.0		54.0	53.0			A Company of the Comp	
LING	LVG. AIR WB. °F	52.8	salari dalah prom	53.8	52.9		CO	MPUTER ROOM	UNITS
caai	MAX AIR PRESSURE DROP, IN. H20	1	· ———	1	1		SYM	BOL	CR∐-1
	MAX. FACE VELOCITY, FPM	600		· 600	600	-	TYPI		AIR COOL
	CHILLED WATER,	350		275	295			AL CFM	5650
	ENTERING WATER	· 50		50	50	1	EXT PRE	. STATÍC SSURE , IN. H2O	0.5
	LEAVING WATER TEMP., F	62	100° 100° 1	62	62			. FAN MOTOR HP	1 2.0
	MAX WATER PRESS. DROP, FT. H ₂ O	10	pulse state	10	10			TOTAL CAPACITY BTU/HR	120,100
	CAPACITY, BTU/HR		2,083,600	· ——		·		SENS, CAPACITY, BTU/HR	109,500
	ENT. AIR DB, °F	~~ ~~ ~~	75				ING	ENT. AIR DB, °F	72
	LVG. AIR DB. °F	FRY FUR POR	125	· · · · · · · · · · · · · · · · · · ·			0	ENT. AIR WB, °F	60
COI	MAX AIR PRESSURE DROP, IN. H20		1				3	COND. AMBIENT TEMPERATURE °F	95
ING	MAX. FACE VELOCITY, FPM		600				HEAT	CAPACITY. BTU/HR	56,300
. ¥	HOT WATER, GPM		100				REH	STAGES	3
표	ENTERING WATER TEMPERATURE, °F		156				HUMID -IFIER	CAPACITY, LB/HR	17.4
	LEAVING WATER TEMPERATURE, °F		115				呈上	KW	6.4
	MAX WATER PRESS. DROP. FT. H20		10					ATION	COMPUTER
LO	CATION	BASEMENT	BASEMENT	ROOF	ROOF			CTRICAL RACTERISTICS	SEE ELEC.
EL CH	ECTRICAL ARACTERISTICS	SEE ELEC. DWGS	SEE ELEC. DWGS	SEE ELEC. DWGS	SEE ELEC. DWGS		REM	IARKS	
	MARKS	1	26	3	4		1) 2	FANS EACH 2.0 F	I P

AHU-3

EXISTING

AHU-4

NEW

- 5 SUPPLY/RETURN

ELECTR: CHARAC

EXISTING	UNIT	TO	BE	REBAL	ANCED	TO	NEW	CAPACITY	SHOWN.					
EXISTING FILTER S							NEW	CAPACITY	SHOWN.	REPLACE	MOTOR	AND	REPLACE	
EXISTING	UNIT	TO	BE	REBAL	ANCED	TO	NEW	CAPACITY	SHOWN.	REPLACE	MOTOR.			

4 NEW UNIT.

(6) ADD INLET GUIDE VANES AS REQUIRED TO VARY AIR FLOW

ADD PLOT
- JUL 2001
08:18
STANLEY

1 INCH

E:\CC_COURT.98132\MØ_1.DGN

1) 2.0

120.100

109,500

56,300

17.4

6.4

COMPUTER ROOM

SEE ELEC. DWGS. SEE ELEC. DWGS.

AIR COOLED

5650

0.5

AIR COOLED

5650

0.5

120.100

109,500

72

60

95

56,300

17.4

6.4

COMPUTER ROOM

AS BUILT

1 2.0

			•		•					,		•						
VARIABLE AIR VO	OLUME BOXE	S												1		·		
SYMBOL	VAV-1	VAV-2	VAV-3	VAV-4	VAV-5	VAV-6	VAV-7	8-VAV	VAV-9	VAV-10	VAV-11	VAV-12 .	VAV-13	VAV-14.	VAV-15	VAV-16	VAV-17	VAV-18
TYPE	DUAL DUCT	DUAL DUCT	DUAL DUCT	DUAL DUCT	DUAL DUCT	DUAL DUCT	DUAL DUCT	DUAL DUCT	DUAL DUCT	DUAL DUCT	DUAL DUCT	DUAL DUCT	DUAL DUCT	DUAL DUCT	DUAL DUCT	DUAL DUCT	DUAL DUCT	DUAL DUCT
	530	520	130	235	1650	250	605	700	320	365	685	465	880	60	570	320	2340	365
MAXIMUM COOLING CFM				95	660	100	240	280	130	145	275	185	350	25	230	130	935	145
MINIMUM COOLING CFM	210	210	50				95	100	45	55	100	70	125	10	180	95	535	70
MAXIMUM HEATING CFM	85	85	20	35	235	35								0.3	0.3	0.3	0.3	0.3
MAXIMUM BOX PRESS. DROP, IN. H2 O	0.3	0.3	0.3	0.3	0.3	0.3	0.3	0.3	0.3	0.3	0.3	0.3	0.3		· · · · · · · · · · · · · · · · · · ·			30
MAXIMUM N.C. LEVEL	30	30	30	30	30	30	30	30	30	30	30	30	30	30	30	30	30	
COOL ENT. AIR DB. F	53	53	53	53	53	53	53	53	53	53	53	53	53	53	53	53 ·	53	5.3
	125	125	125	125	125	125	125	125	125	125	125	125	125	125	125	125	125	125
HEAT ENT. AIR DB. F		74	72	72	72	72	73	72	72	72	72	72	72	72	85	83	79	76
LVG. AIR DB.°F	73	14	16						BOXLLY CLICR	ACUTE AUGTOS IA	L DOODD CTOD EACT	BASEMENT CORR	MICROFILM BASE LAB	BASEMENT CORR	COURT ADMIN.	ASSIT COURT ADM	COURT ADMIN	TAX COLLECTION OPEN OFFICE
LOCATION	BLDG MRT.	BASEMENTLNG.	BASEMENT LNG	BASEMENT LOBBY	RECORD STOR WES	S CORR BASEMENT	PRINT SHOP	PRINT SHOP	PRINT SHOP	CONTR CUSTUDIA	L RCORD STOR EAST	BASEMENT CORK	, BASE LAB	DASCINCTI SOLICI			OFEN OFFICE	
REMARKS							•											

and the second s			•		and the second s	 The second of the second of the	•, • •							•	·		•	
VARIABLE AIR VI	OLUME BOXES					· · · · · · · · · · · · · · · · · · ·									77	VAV-34	VAV-35	VAV-36
SYMBOL	VAV-19	VAV-20	VAV-21	VAV-22 .	VAV-23	VAV-24	VAV-25	VAV-26	VAV-27	VAV-28	VAV-29	VAV-30	VAV-31	VAV-32	VAV-33			
TYPE	DUAL DUCT	DUAL DUCT	DUAL DUCT	DUAL DUCT	DUAL DUCT	DUAL DUCT	DUAL DUCT	DUAL DUCT	DUAL DUCT	DUAL DUCT	DUAL DUCT	DUAL DUCT	DUAL DUCT	DUAL DUCT	DUAL DUCT	DUAL DUCT	DUAL DUCT	DUAL DUCT
MAXIMUM COOLING CFM	160	1060	215	265	270	295	385	280	570	775	665	630	630	1035	865	1100	515	590
	65	340	85	105	200	120	155	110	230	310	265	250	250	415	345	440	205	235
MINIMUM COOLING CFM		155	30	50	90	45	. 120	85	170	225	95	150	150	290	265	300	115	175
MAXIMUM HEATING CFM	50			0.3	0.3	0.3	0.3	0.3	0.3	0.3	0.3	0.3	0.3	0.3	0.3	0.3	0.3	0.3
MAXIMUM BOX PRESS. DROP, IN. H2 O	0.3	0.3	0.3			30	30	30	30	30	30	30	30	30	30	30	30	30
MAXIMUM N.C. LEVEL	30	30	30	30	30		53	53	53	53	53	53	53	53	53	53	53	53
COOL ENT. AIR DB. F	53	53	53	53	53	53					125	125	125	125	125	125	125	125
HEAT ENT. AIR DB. F	125	125	125	125	125	125	125	125	125	125		80 :	80	83	84	. 82	79	84
LVG. AIR DB. F	83	72	72	76	75	·. · 72	84 TAX COMM	83	84	83	72				1ST FLR LOBBY	1ST FLR LOBBY	CASHIER	JUDGE BURKE
LOCATION	SUPER. OF TAX COLLECTION	TAX COLLECT OPEN OFFICE	TAX COLLECT OFFICE	1ST FLR CORR SOUTH	CONFER ROOM	RECEPT	OFFICE	ADMIN OFFICE	OFFICE	SUPER OFFICE	DELINQUENT TAX COLLECT	1ST FLR LOBBY	1ST FLR LOBBY	SMOKE LOUNGE	ISI FER LUDBI	131 121 20001	0.10.12.1	CHAMBERS
REMARKS							,											

orten de la companya											•							
VARIABLE AIR V	OLUME BOXES	S							- And Annual Control of the Control		:	***		·		VAV-52	VAV-53	VAV-54
SYMBOL	VAV-37	VAV-38	VAV-39	VAV-40	VAV-41	VAV-42	VAV-43	VAV-44	VAV-45	VAV-46	VAV-47	VAV-48	VAV-49	VAV-50	VAV-51			
TYPE	DUAL DUCT .	DUAL DUCT	DUAL DUCT	DUAL DUCT	DUAL DUCT	DUAL DUCT	DUAL DUCT	DUAL, DUCT	DUAL DUCT	DUAL DUCT	DUAL DUCT	DUAL DUCT	DUAL DUCT	DUAL DUCT	DUAL DUCT	DUAL DUCT	DUAL DUCT	DUAL DUCT
	450	600	255	350	640	1370	165	270	900	750	610	315	315	575	435	455	600	455
AXIMUM COOLING CFM			100	140	255	550	80	120	600	500	245	125	125	230	175	180	240	180
INIMUM CODLING CFM	180	240				420	30	45	315	180	185	90	90	170	125	135	130	135
AXIMUM HEATING CFM	130	185	75	50	90				0.3	0.3	0.3	0.3	0.3	0.3	0.3	0.3	0.3	0.3
AXIMUM BOX PRESS. ROP. IN. H2O	0.3	0.3	0.3	0.3	0.3	0.3	0.3	0.3		-		30	30	30	30	30	30	30
AXIMUM N.C. LEVEL	30	30	30	30	30	30	30	30	30	30	. 30					53	53	53
OOL ENT. AIR DB,°F	53	53	53	53	53	53	53	53	53	53	53	53	53	53	53			125
EAT ENT. AIR DB.°F	125	125	125	125	125	125	125	125	125	125	125	125	125	125	125	1,25	125	
	83	84	83	72	72	84	72	72	78	72	84	83	83	84	83	84	78	84
VG. AIR DB.°F	REC CRT ADMIN	JUDGE DILLONS CHAMBERS	1ST FLR CORR NORTH	1ST FLR CORR NORTH	SECURITY	1ST FLR CORR WEST	1ST FLR CORR NORTH	POLICE LOUNGE	COURT RM B	COURT RM A	JUDGE MIKELLS CHAMBER	SECRETURY	SECRETURY	JUDGE FREESMANN CHAMBERS	JUDGE FOWLER CHAMBERS	SECRETURY	JURY ASSEMBLY ROOM	SECRETURY
REMARKS		The second secon	790000															

		·				÷ .	•										•	
VARIABLE AIR V	OLUME BOXES)						VAV. 60	VAV-63	VAV64	VAV-65A & B	VAV-66	VAV-67	VAV-68A & B	VAV-69	VAV-70	VAV-71A & B	VAV-72
SYMBOL.	VAV-55	VAV-56	VAV-57	VAV58	VAV-59	VAV-60A&B	VAV-61	VAV-62					DUAL DUCT	DUAL DUCT	DUAL DUCT	DUAL DUCT	DUAL DUCT	DUAL DUCT
TYPE	DUAL DUCT	DUAL DUCT	DUAL DUCT	DUAL DUCT	DUAL DUCT	DUAL DUCT	DUAL DUCT	DUAL DUCT	DUAL DUCT	DUAL DUCT	DUAL DUCT	DUAL DUCT					445	295
MAXIMUM COOLING CFM	435	575	315	315	610	550	400	~ 2130	1370	295	650	225	165	445	295	3000		
			125	125	245	220	160	850	550	240	500	120	65	320	240	3000	320	240
WINIMUM COOLING CFM	175	230					60	655	425	85 .	235	45	25	115	85	. 1075	115	85
MAXIMUM HEATING CFM	125	170	90	90	185	165				· · · · · · · · · · · · · · · · · · ·			0.7	0.3	0.3	0.3	0.3	0.3
MAXIMUM BOX PRESS. DROP. IN. H2O	0.3	0.3	0.3	0.3	0.3	0.3	0.3	0.3	0.3	0.3	0.3	0.3	0.3					30
MAXIMUM N.C. LEVEL	30	30	30	30	30	. 30	30	30	30	30	30	30	30	30	30	30	30	
			53	53	53	53	53	53	53	53	53	53	53	53	53	53	53	53
COOL ENT. AIR DB,°F	53	53					125	125	125	125	125	125	125	125	125	125	125	125
HEAT ENT. AIR DB.°F	125	125	125	125	125	125			<u> </u>				72	72	72	72	72 .	72
LVG. AIR DB. °F	83	84	83	83	84	84	72	84	84	72	76	72	010 ELB CODE				COURTRM E	JURY E
LOCATION	JUDGE GINSBERG CHAMBERS	JUDGE KARPF CHAMBERS	SECRETURY	SECRETURY	JUDGE MORSE CHAMBERS	2ND FLR CORR EAST	2ND FLR LOBBY	2ND FLR CORR WEST	2ND FLR CORR WEST	JURY C	COURT RM C	WITNESS WTG C	EAST	COURTRM D	JURY D	JURY ASS'Y	COURTRIM E	JON 1 E
REMARKS	WITTE SEATON																	

Rosser International, Inc.

Architects and Engineers Atlanta, Savannah, Houston, Los Angeles

128 West Bay St. Savannah, Ga. 31402 (912) 232 1146

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Revisions

Chatham

Sheet Title

SCHEDULES

Job NO. 98132

Drawn SMC

Checked CAH

Date 26-JUL-2001 Sheet No.

M0.2

AS BUILT

1 INCH

E:\CC_COURT.98132\M0_2.DGN

VARIABLE AIR V	VAV-73	VAV-74	VAV-75A & B	VAV-76	VAV-77	VAV-78	VAV-79	VAV-80	VAV-81	VAV-82	VAV-83	· VAV-84	VAV-85	VAV-86	VAV-87	VAV-88	VAV-89	VAV-90
TYPE	DUAL DUCT	DUAL DUCT	DUAL DUCT	DUAL DUCT	DUAL DUCT	DUAL DUCT	DUAL DUCT	DUAL DUCT	DUAL DUCT	DUAL DUCT	DUAL DUCT	DUAL DUCT	DUAL DUCT	DUAL DUCT	DUAL DUCT	DUAL DUCT	DUAL DUCT	DUAL DUCT
MAXIMUM COOLING CFM	165	195	640	295	380	960	275	. 460	460	780	460	310	1900	785	140	515	610	260
MINIMUM COOLING CFM	65	120	500	240	150	385	110	185	185	310	185	125	760	315	55	205	245	105
MAXIMUM HEATING CFM	25	. 45	235	85	125	235	40	130	65	225	65	90	540	115	20	_. 75	150	40
MAXIMUM BOX PRESS.	0.3	0.3	0.3	0.3	0.3	0.3	0.3	0.3	0.3	0.3	0.3	0.3	0.3	0.3	0.3	0.3	0.3	0.3
DROP, IN. H2 O MAXIMUM N.C. LEVEL	30	30	30	30	30	30	30	30	30	. 30	30	30	30	30	30	30	30	30
COOL ENT. AIR DB. F	53	53	53	53	53	53	53	53	53	53	53	53	53	53	53	53	53	53
HEAT ENT. AIR DB.°F	125	125	125	125	125	125	125	125	125	125	125	1,25	125	125	125	125	125	125
LVG. AIR DB.°F	72	72	76	72	85	80	72	83	72	83	72	83	83	72	72	72	. 80	72
OCATION	2ND FLR CORR EAST	COURTRM WING E	COURTRM F	JURY F	CIVIL ADMIN.	CVL RECORDS	CVL RECORDS	ST CRT CLRK ADMIN	CVL RECORDS	CHEIF DEPUTY CRIM	CRIMIN ADMIN	JUDICAL OPS OF	JUDICAL OPS OFF	JUDICAL OPS OFF	3RD FLR LOBBY	3RD FLR CORR	DEED ROOM	DEED ROO
REMARKS	1 m 1 m 1	1											· ·					

			•										,	•		•		
VARIABLE AIR V	OLUME BOXI	ES				••							· · · · · · · · · · · · · · · · · · ·	Appendix and the second			,	
SYMBOL	VAV-91	VAV~92	VAV-93	VAV-94	VAV-95	VAV-96	VAV-97	VAV-98A & B	VAV-99	VAV-100	VAV-101	VAV-102 -	VAV-103	VAV-104	VAV-105	VAV-106	VAV-107	VAV-108
TYPE	DUAL DUCT	DUAL DUCT	DUAL DUCT	DUAL DUCT	DUAL DUCT	DUAL DUCT	DUAL DUCT	DUAL DUCT	DUAL DUCT	DUAL DUCT	DUAL DUCT	DUAL DUCT	DUAL DUCT	DUAL DUCT	DUAL DUCT	DUAL DUCT	DUAL DUCT	DUAL DUCT
MAXIMUM COOLING CFM	1765	1175	1020	405	470	. 190	775	645	95	100	440	460	445	290	190	70	755	. 565
MINIMUM COOLING CFM	705	470	. 4.10	160	190	75	310	300	40	40	175	185	200	115	* 75	30	300	225
MAXIMUM HEATING CFM	410	240	180	125	205	. 30	260	170	15	15 ·	135	135	70	90	30	10	215	80
MAXIMUM BOX PRESS. DROP. IN. H2 O	0.3	0.3	0.3	0.3	0.3	0.3	0.3	0.3	0.3	0.3	0.3	0.3	0.3	0.3	0.3	0.3	0.3	0.3
MAXIMUM N.C. LEVEL	30	30	30	30.	30	30	30	. 30	30	30	30	30	30	30	30	30	30	30
COOL ENT. AIR DB. F	53	53	53	53	53	. 53	53	53	53	53	53	53	53	53	53	53	53	53
HEAT ENT. AIR DB, F	125	125	125	125	125	125	125	125	125	125	125	125	125	125	125	125	125	125
LVG. AIR DB.°F	80	77	75	84	91	72	86	79	72	72	84	83	72 ·	84	72	72	83	72
LOCATION	DEED ROOM	MICROFILM RD RM	MACHINE RM	MIRCOFILM RD RM	BREAKROOM	DEED ROOM	3RD FLR CORR SOUTH	COURTRM M	LIBRARY	JUDGE ANDRE	JUDGE ANDRE	JUDGE BARKER	· CRIMIN ADMIN	CHEIF DEP CRIMI	CVL RECEPT	CVL RECEPT	CVL PROCS	CVE WAITING
REMARKS							333711		,		,							

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VARIABLE AIR	VOLUME BOXE	S		T		T						· · · · · · · · · · · · · · · · · · ·			VAV-123	. VAV-124	VAV-125	VAV-126
SYMBOL	VAV-109	VAV-110	VAV-111.	VAV-112	- VAV-113	VAV-114	VAV-115	'VAV-116	VAV-117	VAV118	VAV-119	VAV-120	VAV-121	VAV-122		· · · · · · · · · · · · · · · · · · ·		
TYPE .	DUAL DUCT	DUAL DUCT	DUAL DUCT	DUAL DUCT	DUAL DUCT	DUAL DUCT	DUAL DUCT	DUAL DUCT	DUAL DUCT	DUAL DUCT	DUAL DUCT	DUAL DUCT	DUAL DUCT	DUAL DUCT	DUAL DUCT	DUAL DUCT	DUAL DUCT	- DUAL DUCT
MAXIMUM COOLING CFM	285	415	280	370	335	675	175	120	190	265	215	640	175	255	175	255	400	100,
MINIMUM COOLING CFM	115	165	. 110	160	135	270	70	50	75 .	105	200	255	70	100	70	100	160	40
MAXIMUM HEATING CFM		130	85	60	50	100	25 .	20	30	40	70	200	50	.75	50	75	125	15
MAXIMUM BOX PRESS.	0.3	0.3	0.3	0.3	0.3	0.3	0.3	0.3	0.3	0.3	0.3	0.3	0.3	0.3	0.3	0.3	0.3	0.3
DROP. IN. H2O MAXIMUM N.C. LEVEL	30	30	30	30	30	30	30	30	30	30	30	30	30	30	30	30	30	30
COOL ENT. AIR DB. F		53	53	53	.53	53	53	53	53	53	53	53	53	· 53	53	53	53	53 ·
HEAT ENT. AIR DB. F		125	125	125	125	125	125	125	125	125	. 125	125	125	125	125	125	125	125
LVG. AIR DB. F	84	85	83	72	72	72	72	72	72	72	. 72	85	83	84	83	84	84	72
LOCATION	CHIEF DEP CVL	MAG STATE CRT	CHIEF DEP	CVL CONF	BK KEEPING	CERTIFICATIONS	CRT DEPUTY	CRT DEPUTY	CRIM DIV CPR OFFICE	APPEALS	CONFER RM	SUPERIOR CRT CLK	CRT DEPUTY	CRT DEPUTY	CRT DEPUTY	CRT DEPUTY	CRT DEPUTY	CRT DUPUTY
REMARKS		CLIK																

VARIABLE AIR VO	OLUME BOXES	}	·					Y				1						
SYMBOL	VAV-127	VAV-128	VAV-129	VAV-130	VAV-131	VAV-132	VAV-133	VAV-134	VAV-135	VAV-136	VAV-137	VAV-138	VAV-139	VAV-140	VAV-141A & B	VAV-142	VAV-143	VAV-144
TYPE	DUAL DUCT	DUAL DUCT	DUAL DUCT	DUAL DUCT	DUAL DUCT	DUAL DUCT	DUAL DUCT .	DUAL DUCT	DUAL DUCT	DUAL DUCT	DUAL DUCT	DUAL DUCT	DUAL DUCT	DUAL DUCT	DUAL DUCT	DUAL DUCT	DUAL DUCT	DUAL DUCT
MAXIMUM COOLING CFM	640	335	335	600	405	280	280	280	280	280	600	455	430	635	435	450	2450	1380
MINIMUM COOLING CFM	255	135	135	240	160	110	110	110	110	110	240	180	170	255	175	180	980	550
MAXIMUM HEATING CFM	185	90	90	170	100	80	80	80	80	80	170	125	105	185	115	60	740	425
MAXIMUM BOX PRESS.	0.3	0.3	0.3	0.3	0.3	0.3	0.3	0.3	0.3	0.3	0.3	0.3	0.3	0.3	0.3	0.3	0.3	0.3
MAXIMUM N.C. LEVEL	30	. 30	30	30	30	30	30	30 .	30	30	30	30	30	30	30	30	30	30
COOL ENT. AIR DB.°F	54	54	54	54	54	54	54	54	54	53	. 54	54	54	54	· , 54	54	54	54
HEAT ENT. AIR DB, F	125	125	125	125	125	125	125	125	125	125	125	125	125	125	125	125	125	125
LVG. AIR DB.°F	84	83	83 .	84	81	84	84	84	84	84	83	83	81	84	82	72 .	84	85
LOCATION	JDGS CHAMBER	SECRETURY	SECRETURY	JDGE BRANNEN	LAW CLRK	LAW CLRK	LAW CLRK	LAW CLRK	LAW CLRK	LAW CLRK	SR JDGE CHAMBER	SR JDGE CHAMBER	DIR ALT DISP RESOLUTIONS	SR JUDGE	4TH FLR CORR EAST	4TH FLR LOBBY	4TH FLR CORR WEST	4TH FLR CORI
REMARKS					,					·	į	·					,	

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Architects and Engineers Atlanta, Savannah, Houston, Los Angeles

128 West Bay St. Savannah, Ga. 31402 (912) 232 1146

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Revisions

ırthouse Chatham

Key Plan

SCHEDULES

Job NO. 98132

Drawn SMC

Checked CAH

Date 26-JUL-2001

ADD PLOT - JUL-2001 08:20 STANLEY

1 INCH

FILCO COURT 98132/MM 3 DGN

REMARKS

REMARKS

OCATION	. COURTRM. J	JURY J	WITNESS WTG J	COURTRM K	JURY K	COURTRM I	COURTRM G	uoni 3	,,,,,,,,,,,,,,,,,,,,,,,,,,,,,,,,,,,,,,,									
VG. AIR DB.°F	75	72	72	72	72	72		JURY G	WITNESS WTG G	COURTRM H	JURY H	4TH FLR CORR EAST	SOUTH LOCK UP 4TH FLOOR	LOBBY CRTRM J	PRESS BOX COURTRM K	4TH FLOOR CORR WEST	WITNESS WTG G	CHEIF ASSES OFFICE
AT ENT. AIR DB. F	125	125	125			3	72	72	72	77	72	72	72	85	72	72		ł
OL ENT. AIR DB.°F				125	125	125	125	125	125	125	125	125	125				72	85
	54	54	54	54	54	54	54	54	54	54			405	125	125	125	125	125
XIMUM N.C. LEVEL	30	30	30	30	30	30	30				54	54	54	54	54	54	54	. 54
XIMUM BOX PRESS.	0.3	0.3	0.3	0.3				30	30	30	30	30	30	30.	30	30	30	
XIMUM HEATING CFM	210	80			0.3	0.3	0.3	0.3	0.3	0.3	0.3	0.3	0.3	0.3		 		30
		80	15	135	80	205	135	80	15	190	80	25			0.3	0.3	0.3	0.3
NIMUM COOLING CFM	500	240	40	400	240	600	400	240	40			25	20	240	30	15	15	115
XIMUM COOLING CFM	715	310	100	565	335	860			40	400	240	70	60	305	80	40	40	145
PE	DUAL DUCT	DUAL DUCT	DUAL DUCT			860	565	310	70	615	300	170	130	760	135	50		
MBOL				DUAL DUCT	DUAL DUCT	DUAL DUCT	DUAL DUCT	DUAL DUCT	DUAL DUCT	DUAL DUCT	DUAL DUCT	DUAL DUCT	DUAL DUCT	DUAL DUCT			50	365
	VAV-145A & B	VAV-146	VAV-147	VAV-148A & B	VAV-149	VAV-150	VAV-151A & B	VAV-152	VAV-153	VAV-154A & B				DUAL DUCT	DUAL DUCT	DUAL DUCT	DUAL DUCT	DUAL DUCT
ARIABLE AIR V	INLUME BOXES				• .						VAV-155	VAV-156	VAV-157	VAV-158	VAV-159	VAV-160	VAV-161	VAV-162

REMARKS																•		
													• •	***		•		
			•			e de la companya de La companya de la co	en e	· · · · · · · · · · · · · · · · · · ·										
ARIABLE AIR	VOLUME BOXE	S		,			100	VAV-170	VAV-171	VAV-172	VAV-173	VAV-174	VAV-175	VAV-176	VAV-177	VAV-178	VAV-179	VAV-180
MBOL	VAV-163	VAV-164	VAV-165	VAV-166 .	VAV-167	VAV-168	VAV-169			DUAL DUCT	DUAL DUCT	DUAL DUCT	DUAL DUCT	DUAL DUCT	DUAL DUCT	DUAL DUCT	DUAL DUCT	DUAL DUCT
PË :	DUAL DUCT	DUAL DUCT	DUAL DUCT	DUAL DUCT	DUAL DUCT	DUAL DUCT	DUAL DUCT	DUAL DUCT	DUAL DUCT		360	150	670	420	220	60	425	575
IMUM COOLING CFM	160	140	260	100	1350	3690	335	21.5	440	845	asher	60	270	170	90	25	170	230
IMUM COOLING CFM		55	105	40	540	1475	135	85	175	340	145		185	120	30	10	60	80
		35	35.	15	185	1025	45	30	60	260	50	20		0.3	0.3	0.3	0.3	0.3
MUM HEATING CFM	0.3	0.3	0.3	0.3	0.3	0.3	0.3	0.3	0.3	0.3	0.3	0.3	0.3		30	30	30	30
• IN. H ₂ O		30	30	30	30	30	30	30	30	30	30	30	30	30	54	54	54	54
MUM N.C. LEVEL			54	54	54	54	54	54	54	54	54	54	54	54		125	125	125
ENT. AIR DB. F		54		125	125	125	125	125	125	125	125	125	125	125	125		72	72
T ENT. AIR DB	F 125	125	125		72	83	72	72	72	85	72	72	83	83	72	72	All and a second	PROBATE CRT
G. AIR DB.°F	83	81	72	72 TAX ACCESSORS	TAX ACCESSORS	TAX ACCESSORS	TAX ACCESSORS OPEN OFFICE	TAX ACCESSORS OPEN OFFICE	TAX ACCESSORS	CMP TECH RM	5TH FLR CORR	5TH FLR LOBBY	CRT REPORTER	CRT REPORTER	STORAGE	PROBATE COURT LOBBY	RECORDS RM	PRODATE CRI
CATION	CHF DEPUTY APPRAISER	CHF DEPUTY APPRAISER	RECEPT	OPEN OFFICE	OPEN OFFICE	OPEN OFFICE	OPEN OFFICE	UPEN UFFICE	OPEN OFFICE				·					
				\				•										

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VARIABLE AIR V	OLUME BOXES	· .							And the state of t	100	VAV-191	VAV-192	VAV-193	VAV-194	VAV-195	VAV-196	VAV-197	VAV-198
SYMBOL	VAV-181	VAV-182	VAV-183	VAV-184	VAV-185	VAV-186	VAV-187	VAV-188	VAV-189	VAV-190			DUAL DUCT	DUAL DUCT	DUAL DUCT	DUAL DUCT	DUAL DUCT	DUAL DUCT
	DUAL DUCT	DUAL DUCT	DUAL DUCT	DUAL DUCT	DUAL DUCT	DUAL DUCT	DUAL DUCT	DUAL DUCT	DUAL DUCT	DUAL DUCT	DUAL DUCT	DUAL DUCT		450	300	285	285	330
YPE	*		165	400	475	320	675	870	215	300	300	110	440			115	115	130
AXIMUM COOLING CFM	585	. 90				130	270	350	85	240	240	45	175	180	120			
INIMUM COOLING CFM	235	40	65	200	190				30	80	80	15	60	135	85	80	80	. 95
AXIMUM HEATING CFM	240	15	25 .	90	130	85	225	120			0.3	0.3	0.3	0.3	0.3	0.3	0.3	0.3
	0.3	0.3	0.3	0.3	0.3	0.3	0.3	0.3	0.3	0.3				30	30	30	30	30
AXIMUM BOX PRESS. ROP. IN. H2O			30	30	30	30	30	30	30	30	30	30	30			54	54	54
AXIMUM N.C. LEVEL	30	30			54	54	54	54	54	54	54	54	54	54	. 54			125
COOL ENT. AIR DB. F	54	54	54	54				125	125	125	125	125	125	125	125	125	125	
HEAT ENT. AIR DB. F	125	. 125	125	125	125	125	125		· · · · · · · · · · · · · · · · · · ·		72	72	72	85	84	83	83	84
	90	72	72	76	83	82	86	72	72	72	**************************************		DESCRI	ASST DIR	SYS ANALYSIS II	COMP PROG ANALYSIS II	SYS ANALYSIS	COMP PROG
LVG. AIR DB,°F			PROBATE CRT	HEARING RM	OFFICE	OFF ICE	JUDGE LEWIS	COMP TECH RM	LIBRARY	TAX ACC CONF	CONF RM	COM COORD	RECEPT	A331 DIN		ANAL 1313 11		1
LOCATION	PROBATE CRT	OFFICE	PRUBAIL CRI	TILMITINO PIN														
REMARKS									and the second		I							

			\wedge						· ·									
VARIABLE AIR V	OLUME BOXES	>			1) VAV-207	VAV-208	VAV-209	VAV-210	VAV-211	VAV-212	VAV-213	VAV-214	VAV-215	VAV-216
SYMBOL	VAV-199	VAV-200	VAV-201	X VAV-202	VAV-203	VAV-204	VAV-205	VAV-206		DUAL DUCT	DUAL DUCT	DUAL DUCT	DUAL DUCT	DUAL DUCT	DUAL DUCT	DUAL DUCT	DUAL DUCT	DUAL DUCT
TYPE	DUAL DUCT	DUAL DUCT	DUAL DUCT	DUAL DUCT	DUAL DUCT	DUAL DUCT	DUAL DUCT	DUAL DUCT	DUAL DUCT		370	350	350	350	350	400	400	450
MAXIMUM COOLING CFM	285	285	250	285	525	190	745	285	500	485		140	140	140	140	160	. 160	180
INIMUM COOLING CFM	115	115	115	115	210	75	300	115	200	195	150	110	110	110	110	125	125	125
		80	80	80	145	25	100	40	195	150	120		0.3	0.3	0.3	0.3	0.3	0.3
AXIMUM HEATING CFM	0.3	0.3	0.3) 0.3	0.3	0.3	0.3	0.3	3 0.3	0.3	0.3	0.3	30	30	30	30	30	30
AXIMUM BOX PRESS. ROP, IN. H2 O	30	30	30	30	30	. 30	30	30	30	30	30	30		54	54	54	54	54
AXIMUM N.C. LEVEL		54	54	3 54	54	54	54	54	{ 54	54	54	54	54	125	125	125	125	125
OOL ENT. AIR DB. F		125	125	125	125	125	125	125	125	125	125	125	125	85	85	85	85	83
HEAT ENT. AIR DB,°F		83	83	83	83	. 72	72	72	30	85	86	85	85		ASST DA	ASST DA	ASST DA	MACHINE AREA
LVG. AIR DB.°F _OCATION	83 NETWK ADMIN	COMP SYS ADM		MNGR TECH SYS	DIR MNGNT INFO SYS	OPN OFFICE	TRAINING AREA	TRAINING AREA	DIST ATTY OFFIC	DA'S SECRET	ASST DA	ASST DA	ASST DA	ASST DA	A331 0A			
REMARKS				J-		,		<u> </u>	1									

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Revisions

No. Date Description 08/03/00 GENERAL REVISION

County Courthouse Chatham

Key Plan

Sheet Title

SCHEDULES

Job NO. 98132

Drawn SMC

Checked CAH

Date 26-JUL-2001 Sheet No.

M0.4

1 INCH

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•			-	·														
VARIABLE AIR \	VOLUME BOXE	S							4					· · · · · · · · · · · · · · · · · · ·			T	T 074
SYMBOL	VAV-217	VAV-218	VAV-219	VAV-220	VAV-221	VAV-222	VAV-223	VAV-224	VAV-225	VAV-226	VAV-227	VAV-228	VAV-229	VAV-230	VAV-231	VAV-232	VAV-233	VAV-234
TYPE	DUAL DUCT	DUAL DUCT	DUAL DUCT	DUAL DUCT	DUAL DUCT	DUAL DUCT	DUAL DUCT	DUAL DUCT	DUAL DUCT	DUAL DUCT	DUAL DUCT	DUAL DUCT	DUAL DUCT	DUAL DUCT	DUAL DUCT	DUAL DUCT	DUAL DUCT	DUAL DUCT
MAXIMUM COOLING CFM		270	410	510	130	130	130	130	130	130	130	130	245	350	130	140	140	140
MINIMUM COOLING CFM	775	110	165	205	50	50	50	50	50	50	50	50	100	140	50	60	60	60
MAXIMUM HEATING CFM		75	160	175	35	35	35	35	35	35	35	35	90	100	35	40	40	40
MAXIMUM BOX PRESS.	0.3	0.3	0.3	0.3	0.3	0.3	0.3	0.3	0.3	0.3	0.3	0.3	0.3	0.3	0.3	0.3	0.3	0.3
DROP. IN. H2 O MAXIMUM N.C. LEVEL	30	30	30	30	30	30	30	30	30	30	30	30	30	30	30	30	30	30
COOL ENT. AIR DB. F		54	54	54	54	54	54	54	54	54	54	54	54	54	54	54	54	54
HEAT ENT. AIR DB, F	125	125	125	125	125	125	125	125	125	125	125	125	125	125	125	125	125	125
LVG. AIR DB.°F	81	83	89	87	83	83	83	83	83	83	83 ·	83	88	83	83	83	83	83
LOCATION	OPEN OFF WEST	SUPPLY ROOM	LIBRARY	CONF RM	ASST DA	ASST DA	STORAGE CORR	ADMIN OFFICE	ASST DA	ASST DA	ASST DA	ASST DA						
REMARKS		,		:														

- Commission of the Commission				•	÷ .		· · · · · · · · · · · · · · · · · · ·		W ⁺	·		,				•		
VARIABLE AIR V	OLUME BOXE	S				•								T			VIV 054	VAV-252A&B
SYMBOL	VAV-235	VAV-236	VAV-237	VAV-238	VAV-239	VAV-240	VAV-241	VAV-242	VAV-243	VAV-244	VAV-245	VAV-246	VAV-247	VAV-248	VAV-249	VAV-250	VAV-251	
TYPE	DUAL DUCT	DUAL DUCT	DUAL DUCT	DUAL DUCT	DUAL DUCT	DUAL DUCT	DUAL DUCT	DUAL DUCT	DUAL DUCT	DUAL DUCT	DUAL DUCT	DUAL DUCT	DUAL DUCT	DUAL DUCT	DUAL DUCT	DUAL DUCT	DUAL DUCT	DUAL DUCT
MAXIMUM COOLING CFM	140	1875	500	315	300	300	300	300	300	340	340	365	240	445	460	915	1015	570
MINIMUM COOLING CFM	60	750	200	125	120	120	120	120	120	135	135	145	95	180	185	365	405	300
MAXIMUM HEATING CFM	40	460	180	110	100	100	100	100	100	115	115	90 -	85	165	245	275	310	185
MAXIMUM BOX PRESS.	0.3	0.3	0.3	0.3	0.3	0.3	0.3	0.3	0.3	0.3	0.3	0.3	0.3	0.3	0.3	0.3	0.3	0.3
DROP. IN. H2 O MAXIMUM N.C. LEVEL	30	30	30	30	30	30	30	30	30	30	30	30	30	. 30	30	30	30	30
	54	54	54	54	54	54	54	54	54	54	54	54	54	54	54	54	54	54
COOL ENT. AIR DB. F	125	125	125	125	125	125	125	125	125	125	125	125	125	125	125	125	125	125
HEAT ENT. AIR DB. F	83	81	87	87	87	87	87	87	87	87	87	81	88	88	94	84	85	81
LVG. AIR DB+°F	ASST DA	OPEN OFF EAST	ASST DA	ASST DA	ASST DA	ASST DA	ASST DA	WAITING	6TH FLR LOBBY	6TH FLR CORR	6TH FLR CORR NTH	BREAK RM	CONF RM	GRAND JURY ROOM				
LOCATION	ASST DA	UPEN UPF CAST	A331 UA	7001.07	AJJI DA	7,00,07	1											
REMARKS															<u> </u>			

		`	,						•		•							
VARIABLE AIR V	OLUME BOXE	S	·							,	1		<u>r</u>			T		VAV-270
SYMBOL	VAV-253	VAV-254	VAV-255	VAV-256	VAV-257	VAV-258	VAV-259	VAV-260	VAV-261	VAV-262	VAV-263	VAV-264	VAV-265	VAV-266	VAV-267	VAV-268	VAV-269	
TYPE	DUAL DUCT -	DUAL DUCT ,	DUAL DUCT	DUAL DUCT	DUAL DUCT	DUAL DUCT	DUAL DUCT	DUAL DUCT	DUAL DUCT	DUAL DUCT	DUAL DUCT	DUAL DUCT	DUAL DUCT	DUAL DUCT	DUAL DUCT	. DUAL DUCT	DUAL DUCT	DUAL DUCT
	335	350	450	370	1070	320	100	320	485	135	135	385	385	460	100	345	170	180
MAXIMUM COOLING CFM	135	140	180	150	430	130	40	130	195	55	55 .	155	. 155	185	40	140	· 70	. 70
MINIMUM COOLING CFM	· · · · · · · · · · · · · · · · · · ·		140	135	260	75	25	135	160	40	40	135	135	165	25	95	50	54
MAXIMUM HEATING CFM MAXIMUM BOX PRESS.	105	110				0.3	0.3	0.3	. 0.3	0.3	0.3	0.3	0.3	0.3	0.3	0.3	0.3	0.3
DROP. IN. H20	0.3	0.3	0.3	0.3	0.3			30	30	30	30	30	30	30	30	30	30	30
MAXIMUM N.C. LEVEL	30	30	30	30	30	30	30						54	54	54	54	54	54
COOL ENT. AIR DB. F	54	54	54	54	54	54	54	54	54	54	54	54	· · · · · · · · · · · · · · · · · · ·				· · · · · · · · · · · · · · · · · · ·	
HEAT ENT. AIR DB,°F	125	125	125	125	125	125	125	125	125	125	125	125	125	125	125	125	125	125
LVG. AIR DB.°F	85	85	85	88	81	. 80	81	90	86	83	83	87	87	87	81	83	84	84 1ST JUDICAL
LOCATION	VICT. ADVOCAT	VICT. ADVOCAT	DIR VICTM WTNS ASSISTANCE	CHIEF VIC ADV	VICT WTNS ASSIS OFFICE	COFFEE RM	OFF ICE	VICT WTNS ASSIS OFFICE	BREAK RM	CRIM INVESTIGAT	CRIM INVESTIGAT	CRIM INVESTIGAT	CRIM INVESTIGAT	OFFICE	OFFICE	CLOSET	OFFICE	ADMIN DIST
REMARKS			ASSISTANCE		0102													

SYMBOL	VAV-271	VAV-272	VAV-273	VAV-274 (VAV-275	VAV-276
TYPE	DUAL DUCT	DUAL DUCT	DUAL DUCT	DUAL DUCT	COOLING ONLY	COOLING ONLY
MAXIMUM COOLING CFM	320	880	545	525	1600	1600
MINIMUM COOLING CFM	130	350	220	210	0	0
MAXIMUM HEATING CFM	95	305	185	175		
MAXIMUM BOX PRESS. DROP, IN. H2 O	0.3	0.3	0.3	0.3	0.3	0.3
MAXIMUM N.C. LEVEL	30	30	30	30	30	30
COOL ENT. AIR DB.°F	54	54	54	54	55	55
HEAT ENT. AIR DB. F	125	125	125	125	N/A	N/A
LVG. AIR DB.°F	83	86	86	86	55	55
LOCATION	RECORDER CRT AD	FILES	OFFICE	OFFICE (COMPUTER RM	COMPUTER RM
REMARKS				}	SINGLE DUCT	SINGLE DUCT

AS BUILT

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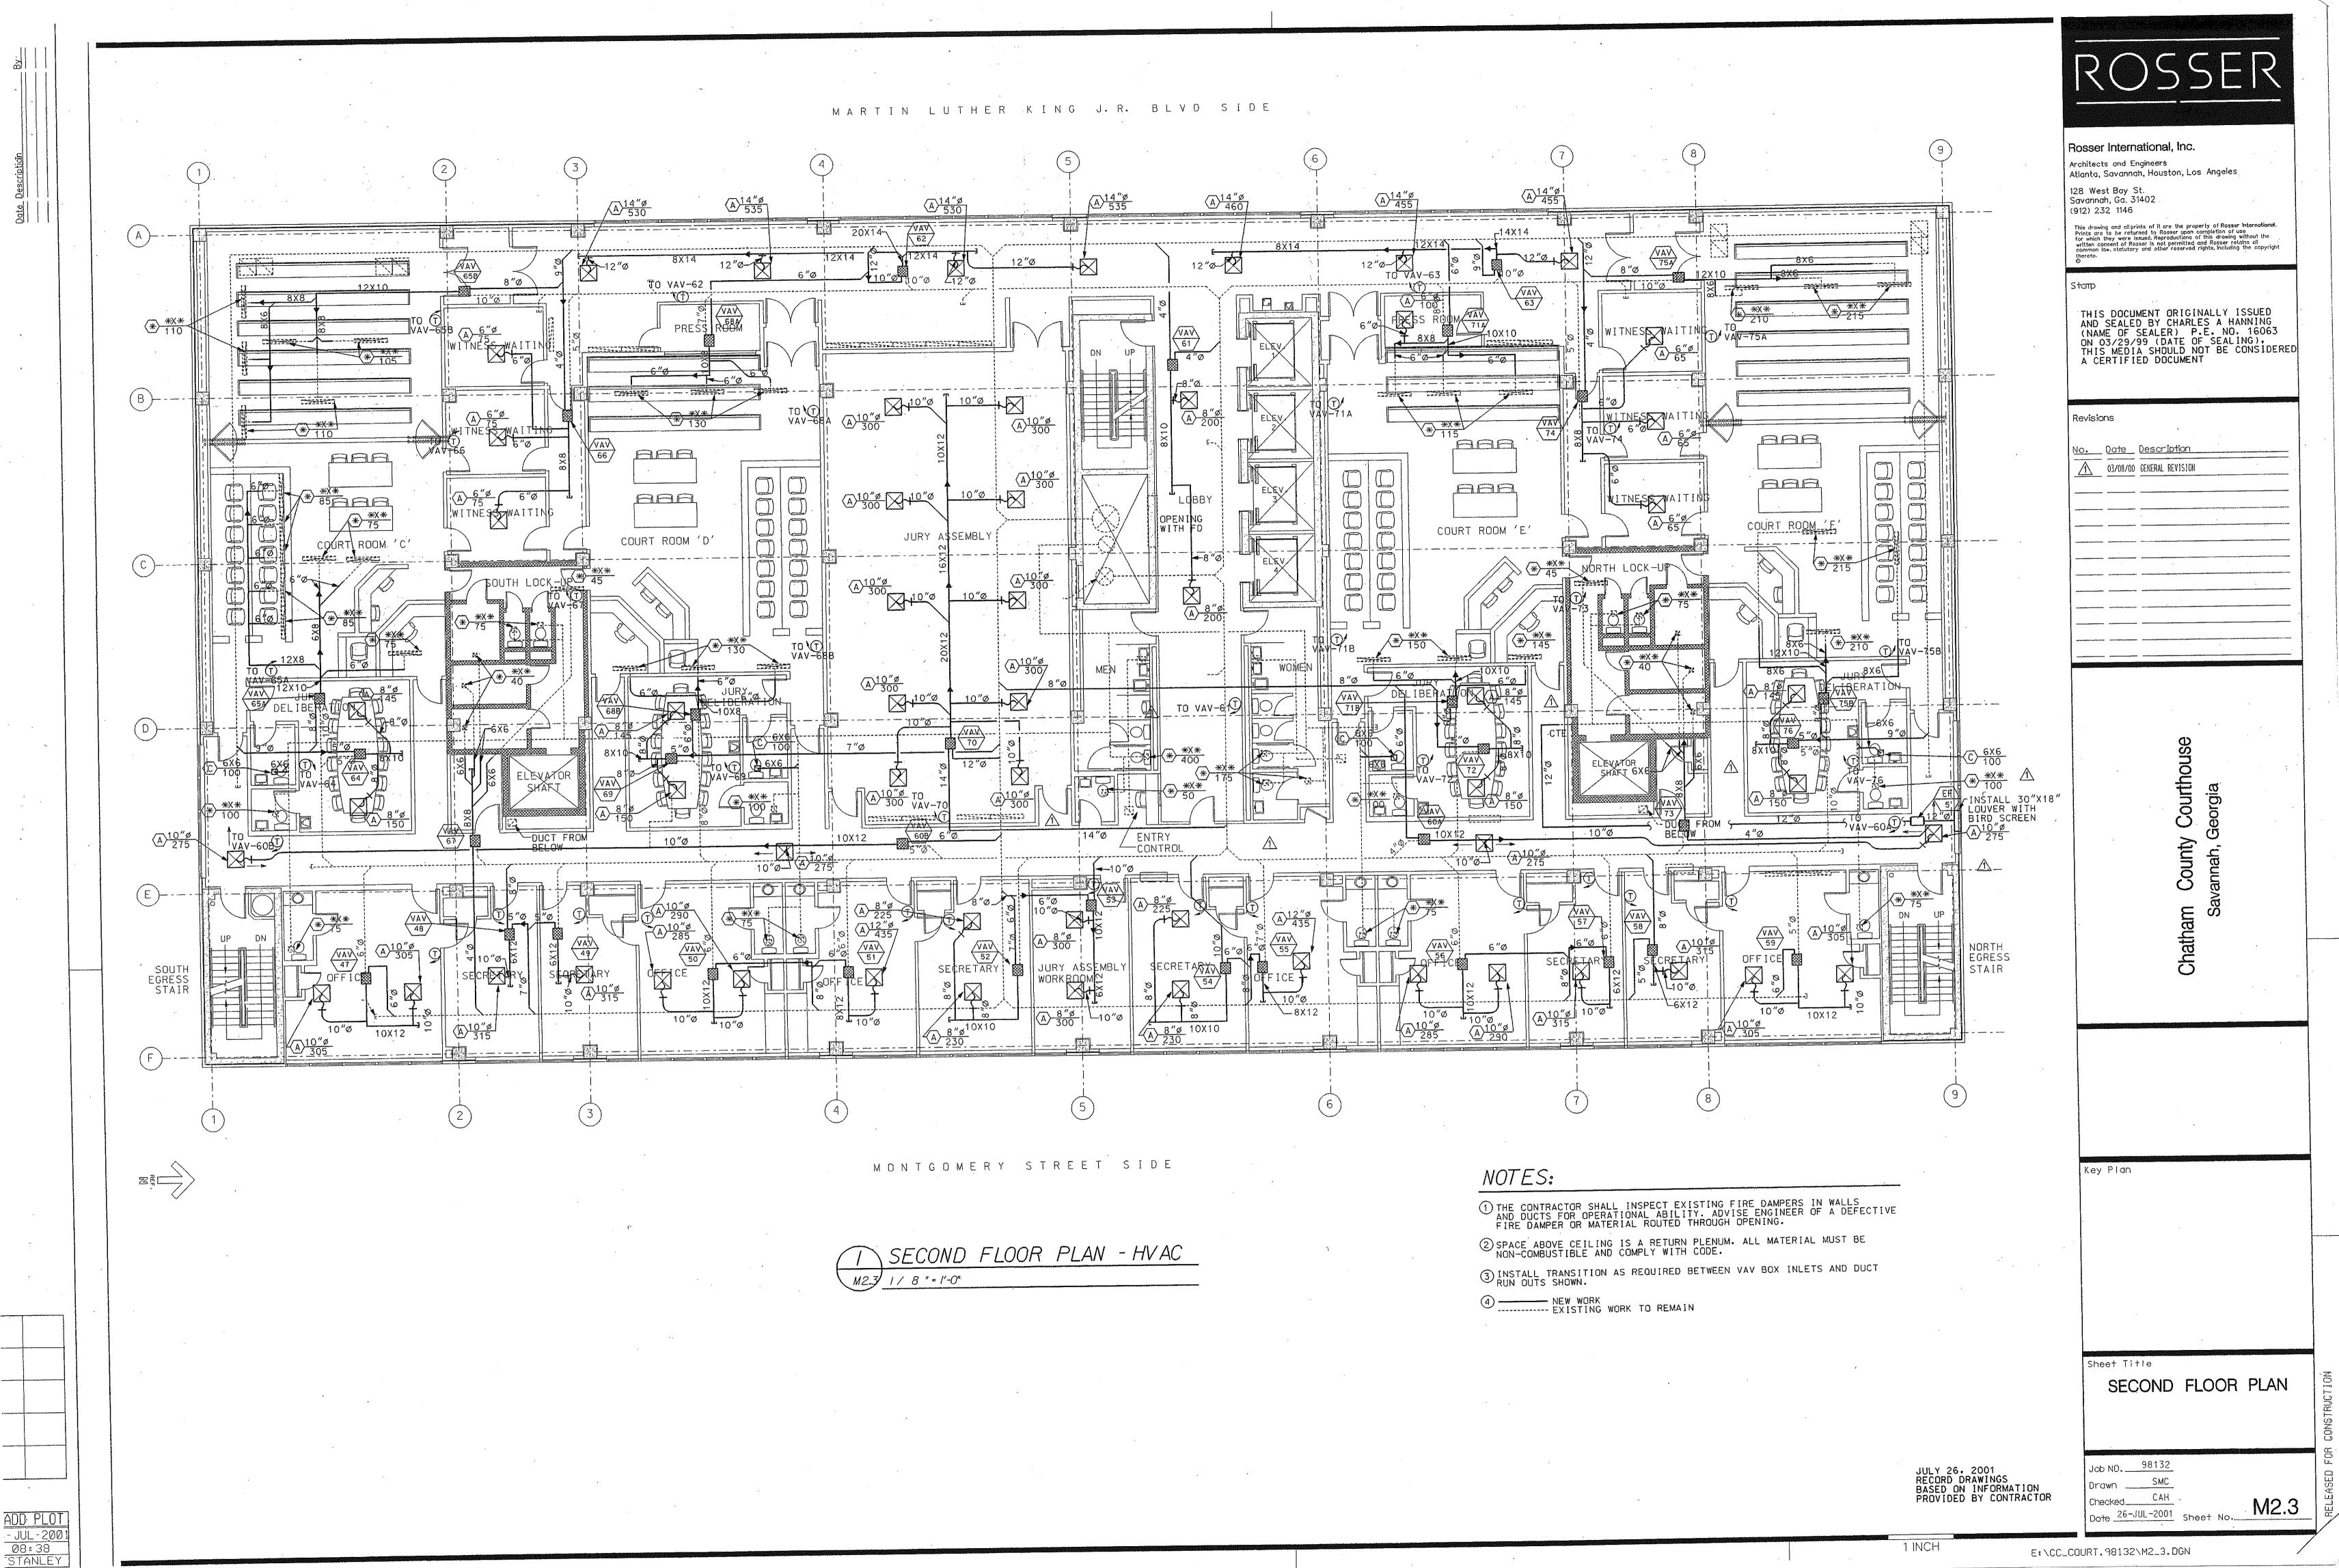
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MARTIN LUTHER KING J.R. BLVD SIDE Rosser International, Inc. Architects and Engineers Atlanta, Savannah, Houston, Los Angeles **EXHAUST** 128 West Bay St. Savannah, Ga. 31402 VAV 427 (912) 232 1146 10"Ø_ This drawing and all prints of it are the property of Rosser International. Prints are to be returned to Rosser upon completion of use for which they were issued. Reproductions of this drawing without the written consent of Rosser retains all common law, statutory and other reserved rights, including the copyright that the control of the copyright that the control of the copyright that the 8″Ø ; *> *X* ***** ***** 150 THIS DOCUMENT ORIGINALLY ISSUED
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(A) 8"ø
240 12X10 Revisions BREAK JAREA No. <u>Date</u> <u>Description</u> 8"ø 7 (. ROOM VAV 34 02/20/01 GENERAL REVISION 14X12 8 "ø COURT --658854423 TAX COLLECTION SUPERINTENDENT OF TAX COLLECT. CLERKS A 8"ø 14X12 TO 112X12AD 6X6AD SECURLIY 12X12AD FD (COURT PAYMENT PLANS) DELINQUENTO AX 8 8 0 0 COLLECTIONO 8 Chatham EGRESS OFFICE EGRESS STAIR MONTGOMERY STREET SIDE NOTES: Key Plan 1) THE CONTRACTOR SHALL INSPECT EXISTING FIRE DAMPERS IN WALLS AND DUCTS FOR OPERATIONAL ABILITY. ADVISE ENGINEER OF A DEFECTIVE FIRE DAMPER OR MATERIAL ROUTED THROUGH OPENING. 2) SPACE ABOVE CEILING IS A RETURN PLENUM. ALL MATERIAL MUST BE NON-COMBUSTIBLE AND COMPLY WITH CODE. 3 INSTALL TRANSITION AS REQUIRED BETWEEN VAV BOX INLETS AND DUCT RUN OUTS SHOWN. FIRST FLOOR PLAN - HVAC 4 ----- NEW WORK EXISTING WORK TO REMAIN Sheet Title FIRST FLOOR PLAN Job ND. 98132 JULY 26, 2001 RECORD DRAWINGS BASED ON INFORMATION PROVIDED BY CONTRACTOR l_{Drawn} SMC CAH Checked___ M2.2 ADD PLOT 3-JUL-2001 08:37 ISTANLEY Date 26-JUL-2001 Sheet No.

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MARTIN LUTHER KING J.R. BLVD SIDE JUDICAL OPERATIONS L. OPEN 860 FILCE VAV-35 VAV-87 OPENING 10"Ø-10"ø 10X12 A) 10"ø 255 VAV-112 10"øJ SOUTH EGRESS STAIR A 8″ø√ 220 MONTGOMERY STREET SIDE NOTES: THIRD FLOOR PLAN - HVAC M2.4 1/8"=1'-0" 4 ----- NEW WORK EXISTING WORK TO REMAIN

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Chatham

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SPACE ABOVE CEILING IS A RETURN PLENUM, ALL MATERIAL MUST BE NON-COMBUSTIBLE AND COMPLY WITH CODE.

3 INSTALL TRANSITION AS REQUIRED BETWEEN VAV BOX INLETS AND DUCT RUN OUTS SHOWN.

Sheet Title THIRD FLOOR PLAN

Key Plan

Drawn SMC

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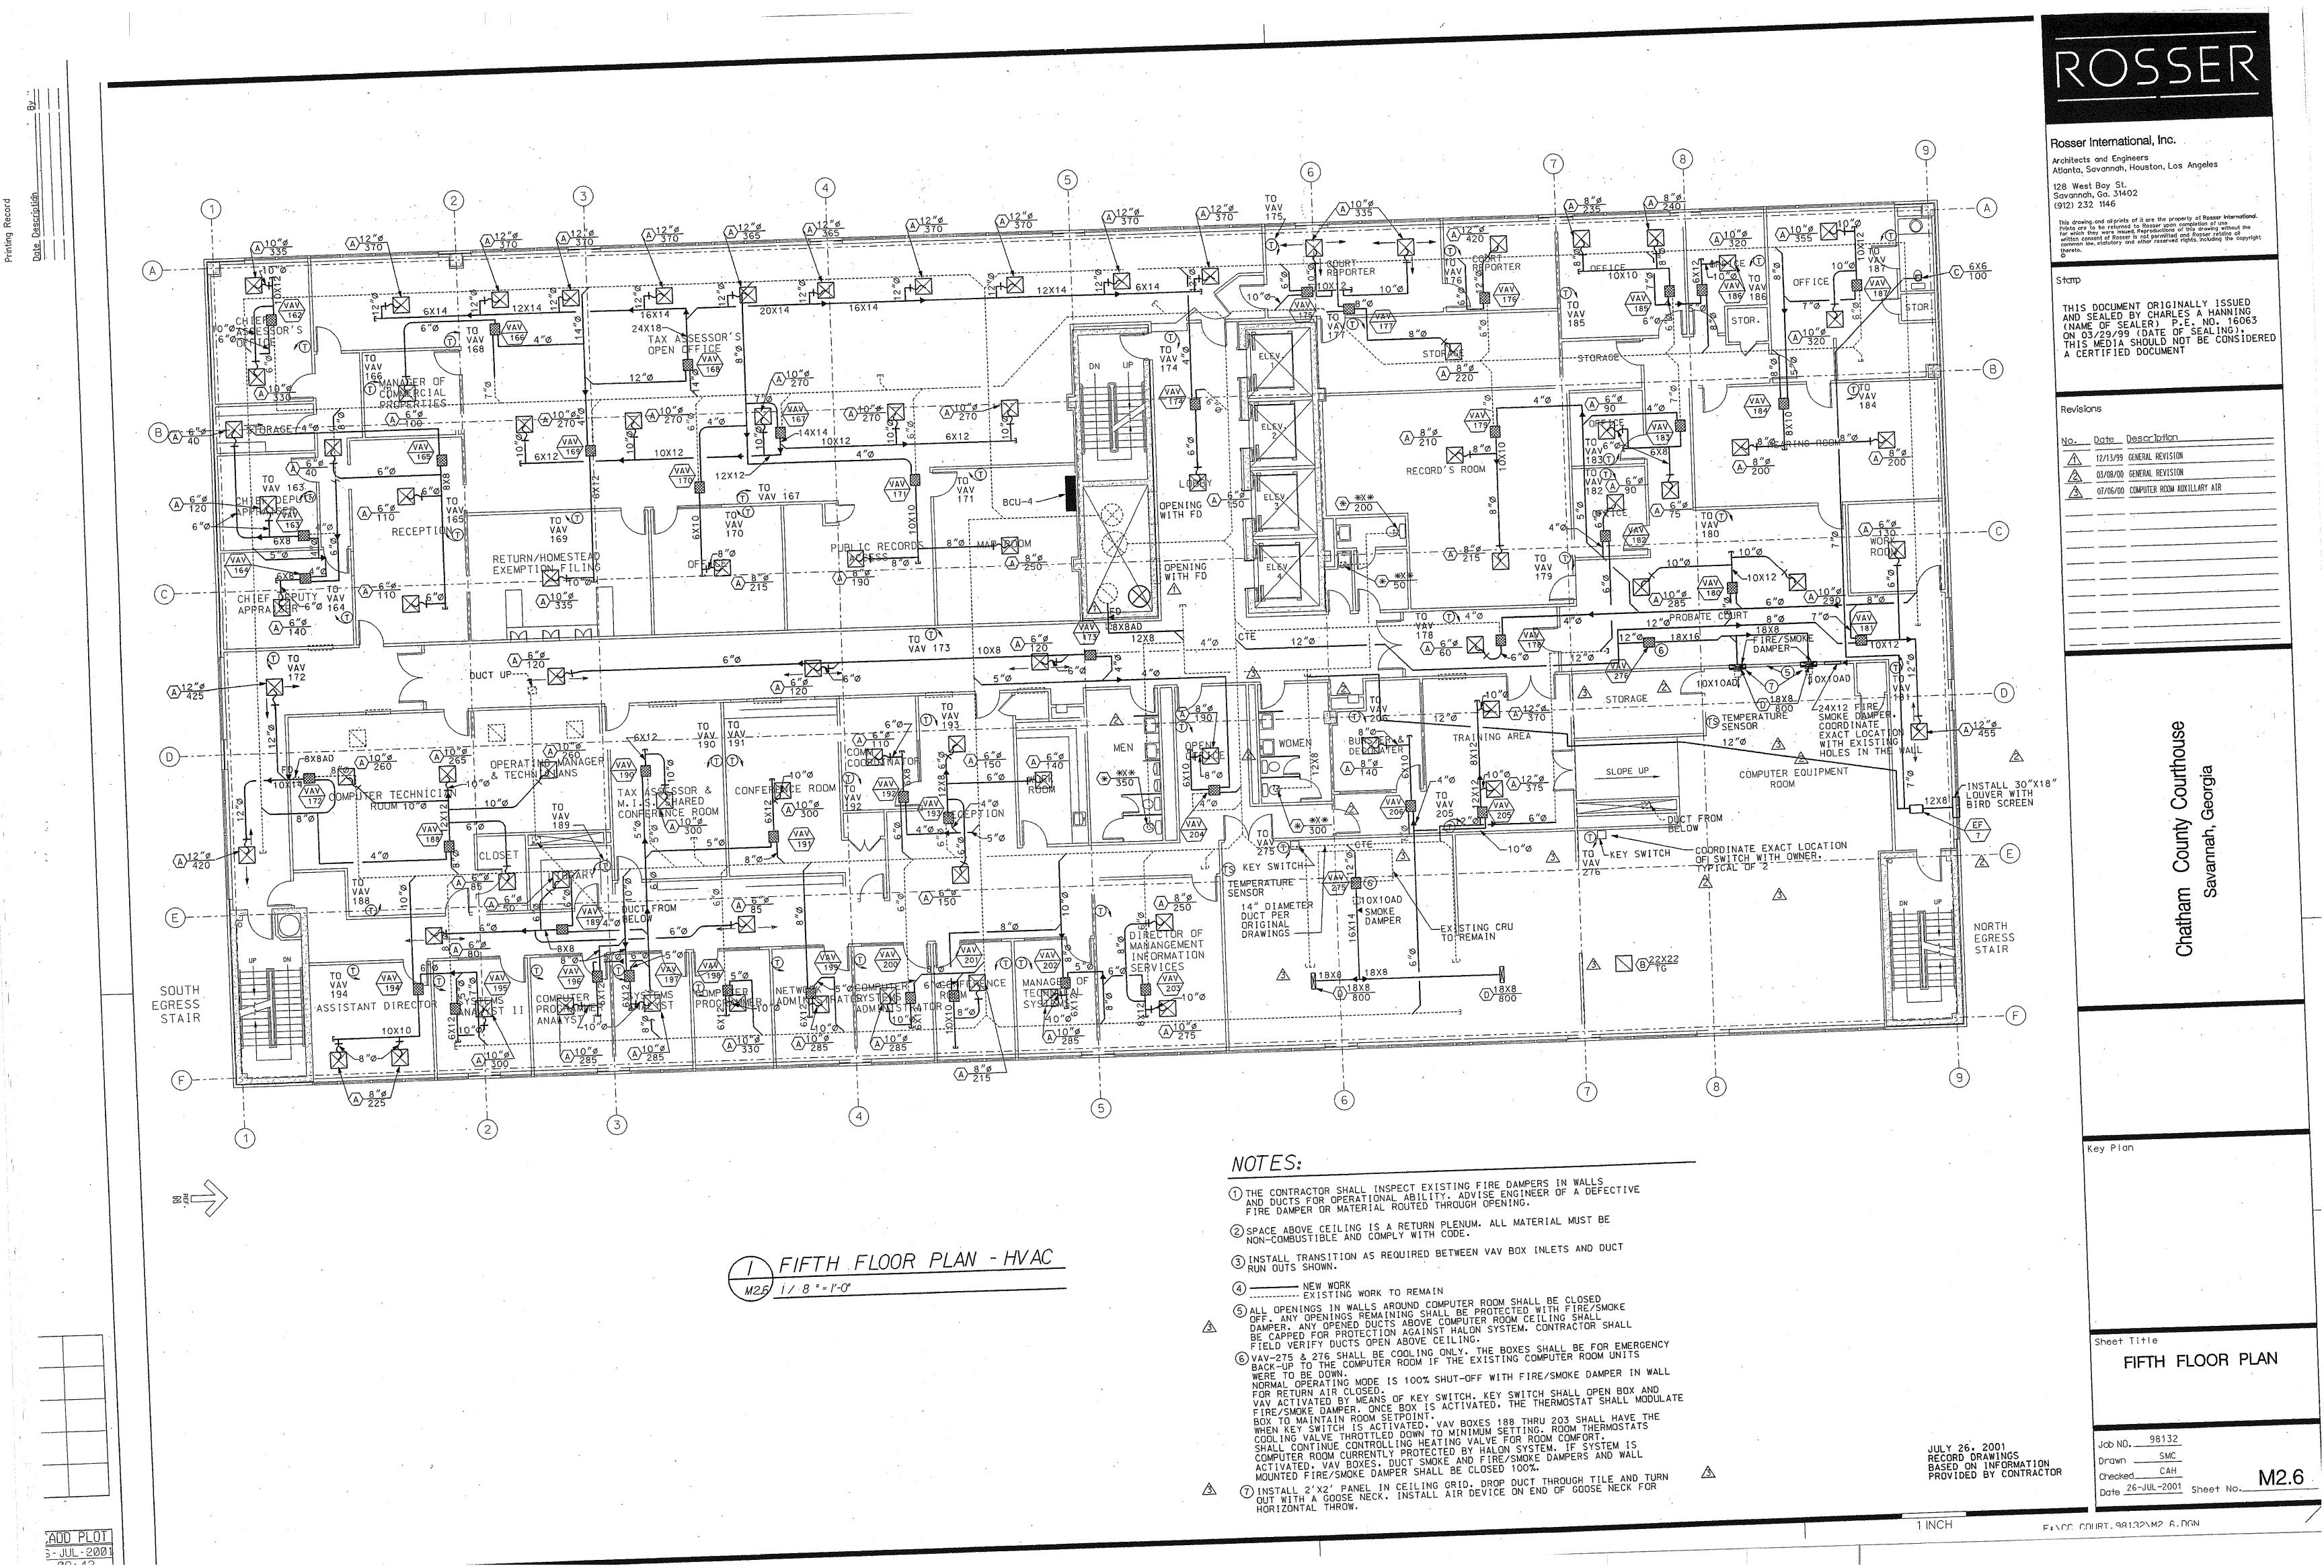
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MARTIN LUTHER KING J.R. BLVD SIDE LINE STLYE EXISTING TO REMAIN. TYP. TVAV 254 TO VAV 212 VAV 213- VAV 215 GRAND JURY RODM TD VAV 260 LOBBY WITNESS ROOM TO VAV 249 OPEN OFFICE EGRESS STAIR TO VAV 274 VAV 273 TO VAV 266 MO.NTGOMERY STREET SIDE 1) THE CONTRACTOR SHALL INSPECT EXISTING FIRE DAMPERS IN WALLS AND DUCTS FOR OPERATIONAL ABILITY. ADVISE ENGINEER OF A DEFECTIVE FIRE DAMPER OR MATERIAL ROUTED THROUGH OPENING. SIXTH FLOOR PLAN - HVAC 2 SPACE ABOVE CEILING IS A RETURN PLENUM. ALL MATERIAL MUST BE NON-COMBUSTIBLE AND COMPLY WITH CODE. 3 INSTALL TRANSITION AS REQUIRED BETWEEN VAV BOX INLETS AND DUCT 1/8"=1'-0" 4 _____ NEW WORK EXISTING WORK TO REMAIN JULY 26, 2001 RECORD DRAWINGS BASED ON INFORMATION PROVIDED BY CONTRACTOR

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